

KANSAS STATE UNIVERSITY



STUDENT UNION RENOVATION

PROJECT NO. A-012552 BUILDING NO. 36700-00101

MANHATTAN, KANSAS 66506

SHEET INDEX

G000	COVER SHEET
G001	GENERAL INFORMATION
A002	LOWER LEVEL-EXISTING
A003	GROUND LEVEL-EXISTING
A004	FIRST LEVEL-EXISTING
A005	SECOND LEVEL-EXISTING
A006	THIRD LEVEL-EXISTING
A007	LOWER LEVEL-DEMOLITION PLAN
A008	GROUND LEVEL-DEMOLITION PLAN
A009	FIRST LEVEL-DEMOLITION PLAN
A010	SECOND LEVEL- DEMOLITION PLAN
A011	THIRD LEVEL- DEMOLITION PLAN
A102	LOWER LEVEL PLAN
A103	GROUND LEVEL PLAN
A104	FIRST LEVEL PLAN
A105	SECOND LEVEL PLAN
A106	THIRD LEVEL PLAN
A107	GROUND LEVEL SOUTH ENTRANCE PLAN
A108	GROUND LEVEL SOUTHWEST PLAN
A109	GROUND LEVEL- NORTHWEST AND CENTRAL
A110	GROUND LEVEL- EAST PLAN
A111	FIRST LEVEL- SOUTHWEST PLAN
A112	FIRST LEVEL- NORTHWEST PLAN
A113	FIRST LEVEL- WEST CENTRAL PLAN
A114	ENLARGED ELEVATOR EL003 PLANS
A115	FIRST LEVEL SOUTH ENTRANCE PLAN
A116	FIRST LEVEL- NORTH ENTRANCE PLAN
A117	FIRST LEVEL- EAST PLAN
A118	ROOFING PLAN
A201	EXTERIOR ELEVATIONS- DEMOLITION
A202	EXTERIOR ELEVATIONS- DEMOLITION
A203	EXTERIOR ELEVATIONS
A204	EXTERIOR ELEVATIONS
A301	SECTIONS

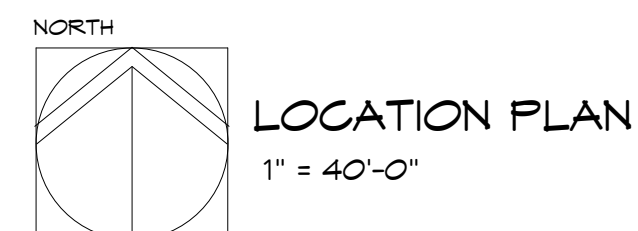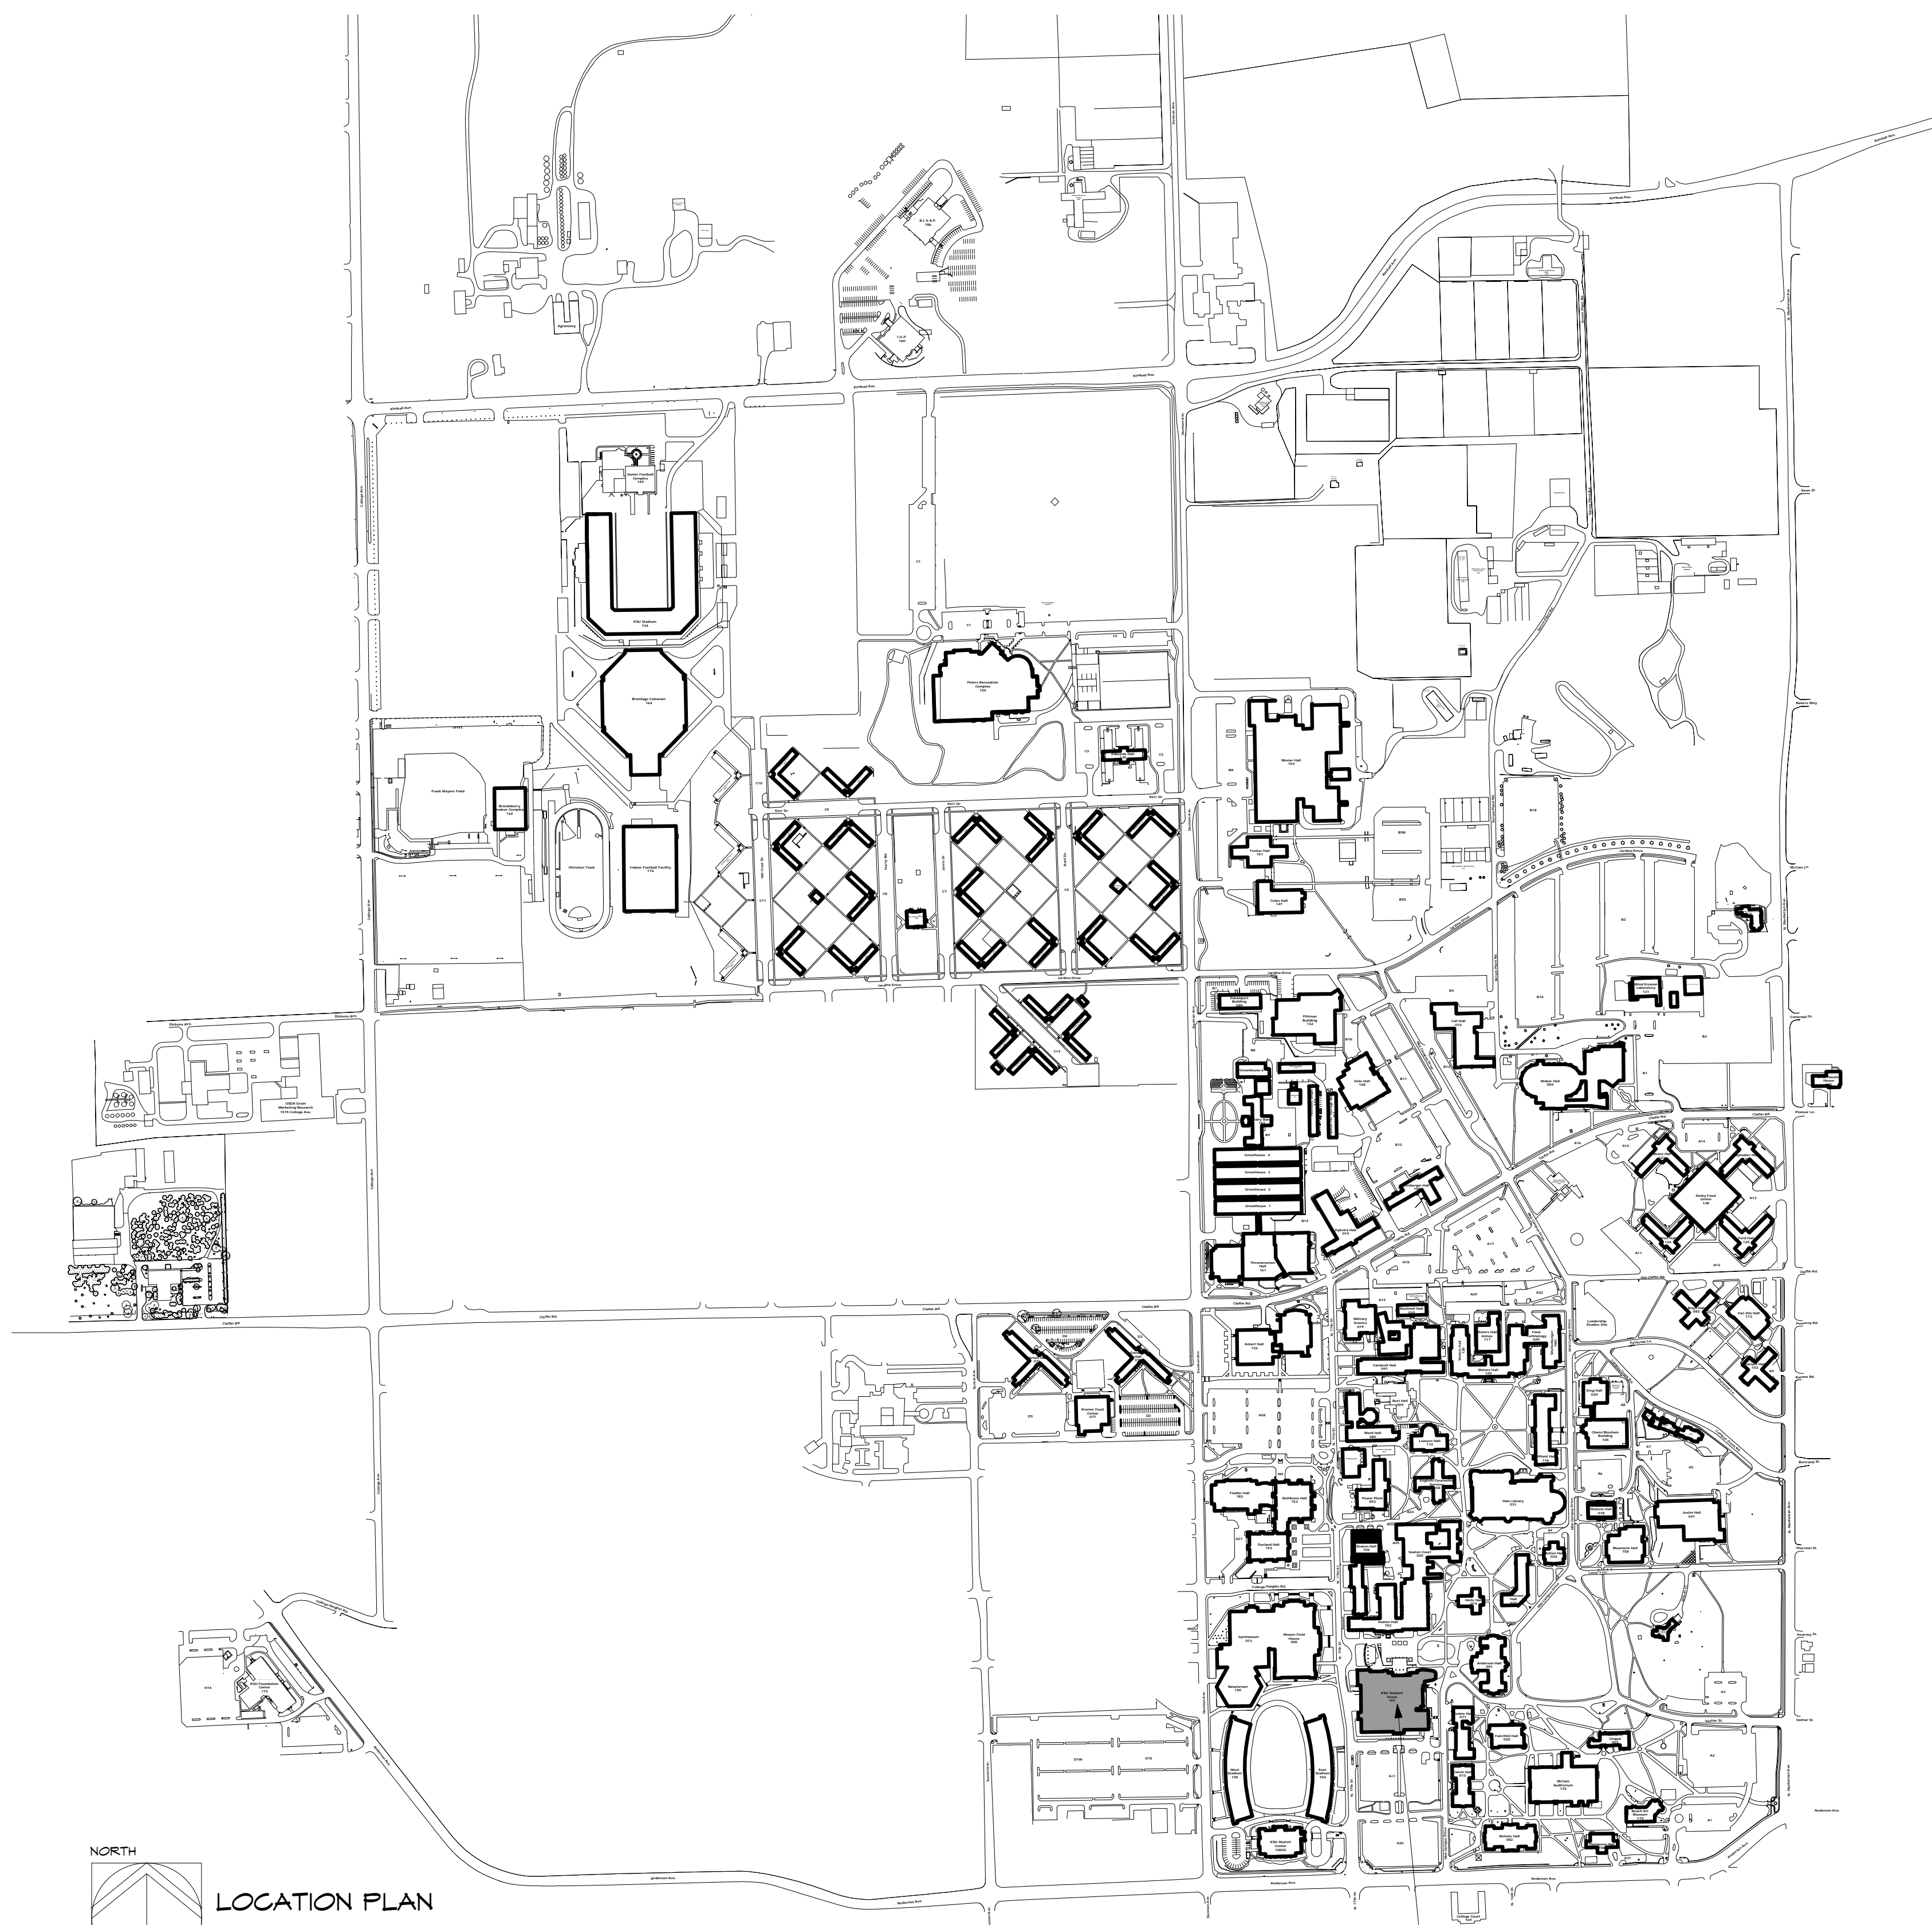

PROJECT LOCATION

KANSAS STATE UNIVERSITY

BBN
BBN ARCHITECTS INC
218 PONTIAC AVENUE, MANHATTAN, KS 66502
PHONE: (785) 739-4922 FAX: (785) 739-4944

WORKSHOP
WORKSHOP ARCHITECTS INC

OSE
Orazem & Scalora
Engineering, P.A.
Manhattan, Kansas
Project Number 13060-1
Copyright © Orazem & Scalora Engineering, P.A. 2016

PROGRESS DOCUMENT
NOT FOR CONSTRUCTION

KSU DWG NO.
DR 2014-XXX

SHEET
OF

TOTAL SHEETS IN SET
XXX

Department of Administration
Office of Land Use Management
Land Use Office Building
800 SW Jackson, Suite 700
Topeka, Kansas 66612-1216
Phone 785-236-8899
Fax 785-296-8898

KANSAS STATE UNIVERSITY
STUDENT UNION RENOVATION
KSU STUDENT UNION- MANHATTAN, KS 66502
BUILDING NUMBER 36700-00101
DATE: Issue
By: Author
Checked By: Checkerev: No
Date

COVER SHEET

A-012552

G000

SCHEMATIC DESIGN

ABBREVIATIONS:

THE FOLLOWING LIST OF ABBREVIATIONS MAY BE USED IN THE CONTRACT DOCUMENT DRAWINGS.

&	AND	MAX.	LIGHTWEIGHT CONCRETE
∠	ANGLE	MECH.	MECHANICAL
⊙	AT	MFG.	MANUFACTURING
∅	DIAMETER	MFR.	MANUFACTURER
#	NUMBER OR POUND	MIN.	MINIMUM
		MIR.	MIRROR OR MIRRORRED
ACUST.	ACOUSTICAL	MISC.	MISCELLANEOUS
ADJ.	ADJUSTABLE	MTD.	MOUNTED
A.F.F.	ABOVE FINISHED FLOOR	MTL.	METAL
ALUM.	ALUMINUM	N/A	NOT APPLICABLE
APPROX.	APPROXIMATE	N.I.C.	NOT IN CONTRACT
ARCH.	ARCHITECTURAL	NO.	NUMBER
		NOM.	NOMINAL
BD.	BOARD	N.P.S.	NOMINAL PIPE STANDARD
BLDG.	BUILDING	N.T.S.	NOT TO SCALE
BLKG.	BLOCKING		
B.O.	BOTTOM OF		
BRG.	BEARING	O.C.	ON CENTER
		O.D.	OUTSIDE DIAMETER DIMENSION
B.S.	BOTH SIDES	O.H.	OPPOSITE HAND
		OPNG.	OPENING
∅	CENTERLINE	OVHD.	OVERHEAD
CH	CHANNEL	OZ.	OUNCE
C.J.	CONTROL JOINT		
CLG.	CEILING		
C.M.U.	CONCRETE MASONRY UNIT	PL.	PLATE
COL.	COLUMN	PLBG.	PLUMBING
CONC.	CONCRETE	PLYWD.	PLYWOOD
CONN.	CONNECTION	POL.	POLISHED
CONSTR.	CONSTRUCTION	PR.	PAIR
CONT.	CONTINUOUS	PT.	POINT
CONTR.	CONTRACTOR	PTD.	PAINTED
CTR.	CENTER	QTY.	QUANTITY
		R	RISER OR RADIUS
DBL.	DOUBLE	R.C.P.	REFLECTED CEILIN PLAN
DIA.	DIAMETER	RE.	REFERENCE
DIM.	DIMENSION	REINF.	CONNECTION
DN.	DOWN	REQ'D.	REQUIRED
DR.	DOOR	REV.	REVISION OR REVERSED
DWG.	DRAWING	RM.	ROOM
		R.O.	ROUGH OPENING
EA.	EACH	S.C.	SOLID CORE OR SEALED CONCRETE
E.F.	EACH FACE		
E.L.	ELEVATION		
ELEC.	ELECTRICAL	SCHED.	SCHEDULE
ELEV.	ELEVATOR	SECT.	SECTION
EQ.	EQUAL	S.F.	SQUARE FOOT
EQUIP.	EQUIPMENT	SHT.	SHEET
E.S.	EACH SIDE	SIM.	SIMILAR
EXP.	EXPANSION	SPEC.	SPECIFICATION(S)
EXIST.	EXISTING	SP. HD.	SPRINKLER HEAD
EXT.	EXTERIOR	SQ.	SQUARE
E.W.	EACH WAY	S.S.	STAINLESS STEEL
		STD.	STANDARD
FIN.	FINISH	STL.	STEEL
FL.	FLOOR	STO.	STORAGE
F.O.F.	FACE OF FINISH	STRUCT.	STRUCTURAL
F.O.S.	FACE OF STUD	SQ. YD.	SQUARE YARD
FR.	FRAME	SYS.	SYSTEM
FT.	FOOT OR FEET		
FURR.	FURRING	T	TREAD
F.D.	FLOOR DRAIN	TEL.	TELEPHONE
		TEMP.	TEMPORARY
GA.	GAUGE	T.O.	TOP OF
GALV.	GALVANIZED	T.O.D.	TOP OF DECK
GL.	GLASS	T.O.S.	TOP OF SLAB/STEEL
G.S.	GROUT SOLID	T.O.W.	TOP OF WALL
GYP. BD.	GYPSUM BOARD	TV	TELEVISION
		TYP.	TYPICAL
HDW.	HARDWARE	UN.O.	UNLESS NOTED OTHERWISE
HDWD.	HARDWOOD	VERT.	VERTICAL
H.M.	HOLLOW METAL		
HORIZ.	HORIZONTAL		
HT.	HEIGHT		
		W/	WITH
LD.	INSIDE DIAMETER DIMENSION	W/I	WITHIN
IN.	INCH	W/O	WITHOUT
IN.	INFORMATION	W/D.	WOOD
INSUL.	INSULATION	W/DW.	WINDOW
INT.	INTERIOR	WT.	WEIGHT
L.	LONG LENGTH		
LT. (LTG.)	LIGHT LIGHTING		
L.W.C.	MAXIMUM		

MATERIAL IDENTIFICATION KEY:

	CONCRETE
	CONCRETE MASONRY UNITS
	PRECAST CONCRETE
	EARTH
	STEEL
	DISCONTINUOUS LUMBER
	CONTINUOUS LUMBER
	RIGID INSULATION
	BLANKET INSULATION
	GYPSUM BOARD
	PLYWOOD
	FINISHED WOOD
	GRANULAR FILL
	METAL STUD FRAMING
	WOOD STUD FRAMING


DIMENSIONING CRITERIA:

ALL DRAWINGS ARE INTENDED TO BE COMPLIMENTARY. NOTIFY THE ARCHITECT OF ANY DIMENSIONING DISCREPANCY PRIOR TO PROCEEDING.


DIMENSIONS ARE AS IDENTIFIED ON THE DOCUMENTS AND AS ESTABLISHED BY CRITERIA. THIS INVOLVES ESTABLISHING TYPICAL RULES GOVERNING PARTITION LOCATIONS AND THEN DIMENSIONING ONLY THE EXCEPTION TO THESE RULES. TYPICAL DIMENSIONING CRITERIA ARE OUTLINED BELOW.

COLUMN IDENTIFICATION DETAILS WILL GOVERN ALL DIMENSIONS AND FEW DIMENSIONS WILL BE SHOWN ON THE SMALL SCALE PLANS.


A. COLUMN GRIDS ARE DRAWN ACCORDINGLY:

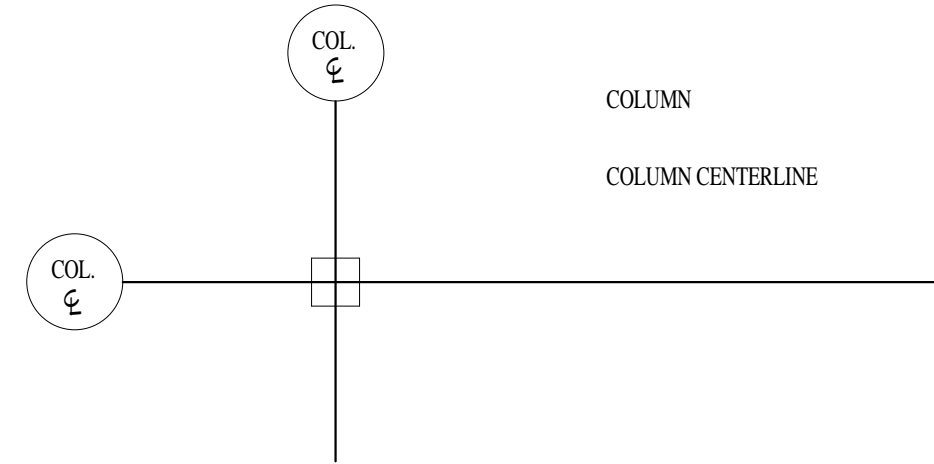


B. PARTITIONS CENTERED ON COLUMN OR GRID LINES WILL NOT BE DIMENSIONED ON THE PLANS, BUT DRAWN ACCORDINGLY:

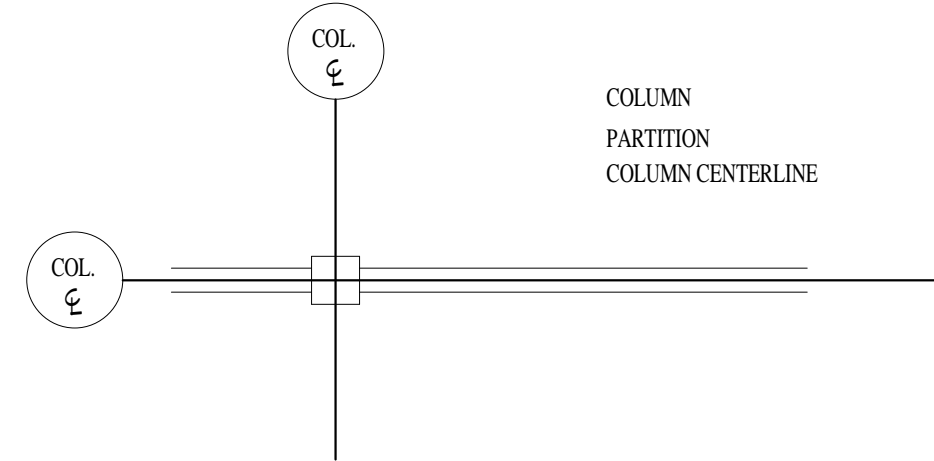

C. PARTITIONS WITH THE FINISHED FACE FLUSH WITH THE COLUMN OR GRID LINE WILL NOT BE DIMENSIONED ON THE PLANS, BUT WILL BE DRAWN ACCORDINGLY:

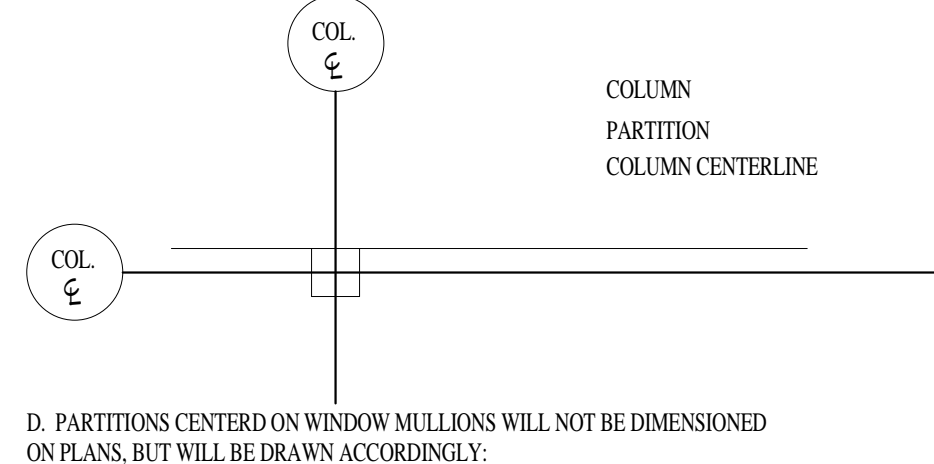

D. PARTITIONS CENTER ON WINDOW MULLIONS WILL NOT BE DIMENSIONED ON PLANS, BUT WILL BE DRAWN ACCORDINGLY:

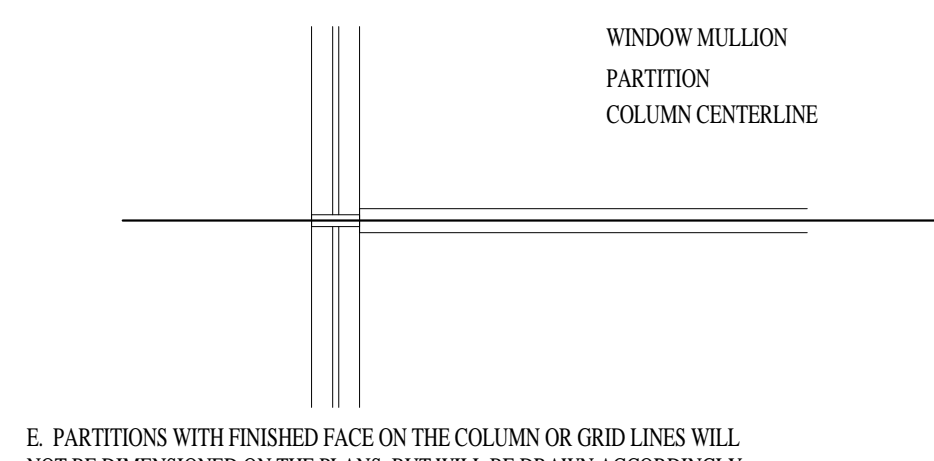


E. PARTITIONS WITH FINISHED FACE ON THE COLUMN OR GRID LINES WILL NOT BE DIMENSIONED ON THE PLANS, BUT WILL BE DRAWN ACCORDINGLY:




F. FOR OPENINGS IN PARTITIONS OR WALLS:

1. WHEN ONE OCCURS AT A COLUMN OR GRID LINE, NO DIMENSIONS WILL BE SHOWN ON THE PLANS, THE OPENING WIDTH WILL BE ESTABLISHED BY EITHER CRITERIA OR SCHEDULES.
2. WHEN NEITHER JAMB OCCURS AT A PARTITION INTERSECTION, AT A COLUMN OR GRID LINE, ONE JAMB WILL BE LOCATED DIMENSIONALLY BY THE DETAIL.
3. WHEN ONE JAMB IS LOCATED BY AN INTERSECTING PARTITION, THE FOLLOWING DIAGRAM APPLIES:

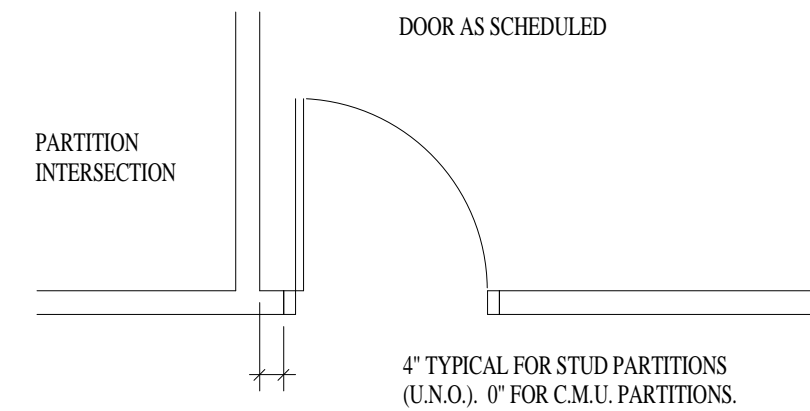

4. WHEN ONE JAMB IS LOCATED BY A COLUMN, THE FOLLOWING DIAGRAM APPLIES:

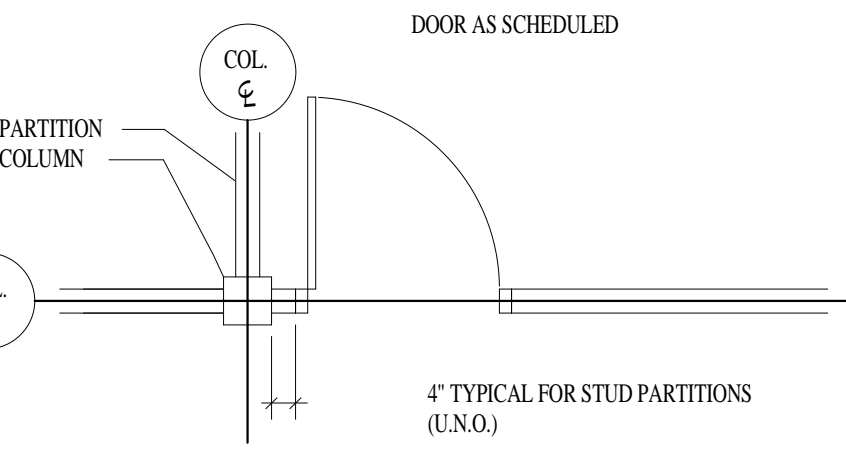


G. STUD PARTITIONS ARE DIMENSIONED FROM THE FACE OF ONE UNIT TO THE FACE OF ANOTHER UNIT. AT EXTERIOR WALLS DIMENSIONS ARE FROM FACE OF SHEATHING TO FACE OF ANOTHER UNIT.


H. MASONRY PARTITIONS ARE DIMENSIONED FROM THE NOMINAL FACE OF C.M.U., BRICK OR STONE TO THE FACE OF ANOTHER UNIT.

GRAPHIC SYMBOLS/STANDARDS:

A. COLUMN AND/OR GRID LINES:

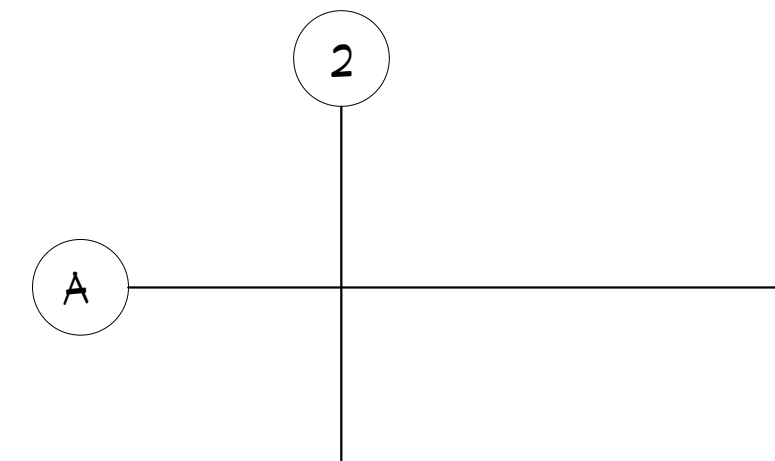

B. FLOOR PLAN MATCHLINE SYMBOL:

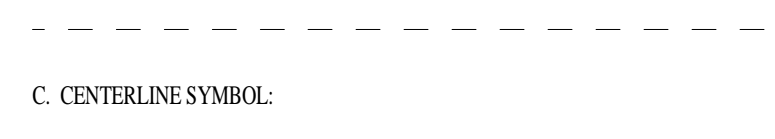


C. CENTERLINE SYMBOL:




D. BAR GRAPH SYMBOL:




E. NORTH ARROW:

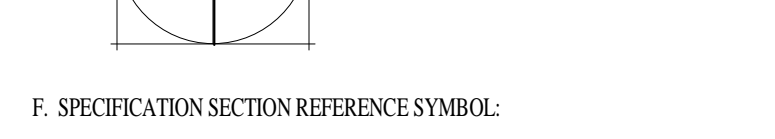


F. SPECIFICATION SECTION REFERENCE SYMBOL:

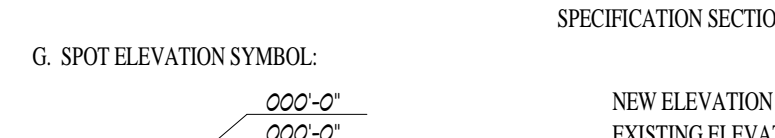

G. SPOT ELEVATION SYMBOL:

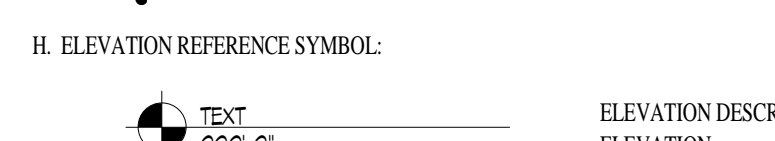

H. ELEVATION REFERENCE SYMBOL:

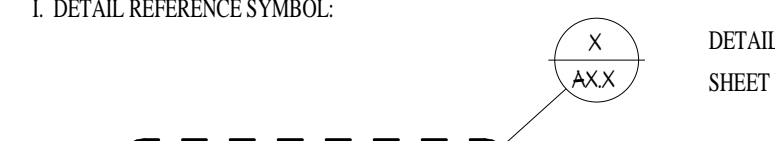


I. DETAIL REFERENCE SYMBOL:




J. INTERIOR ELEVATION REFERENCE SYMBOL:




K. BUILDING SECTION REFERENCE SYMBOL:

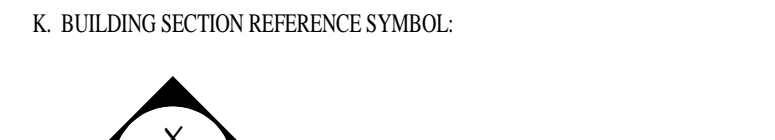

L. DETAIL REFERENCE SYMBOL:

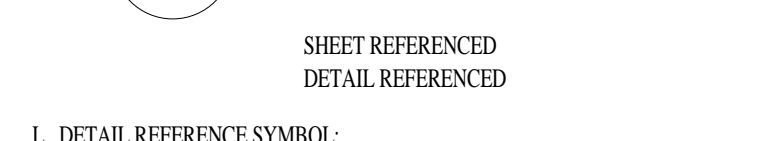


M. DETAIL REFERENCE SYMBOL:

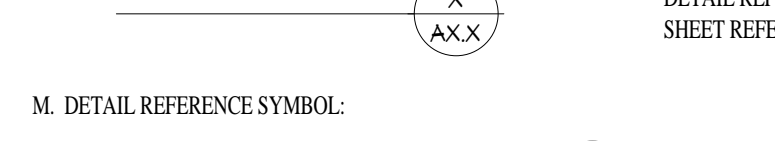


N. DOOR REFERENCE SYMBOL:




O. ROOM NUMBER/NAME SYMBOL:

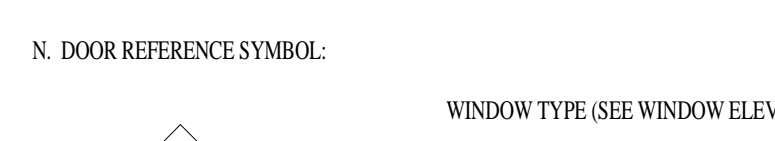


P. ACCESSORY REFERENCE SYMBOL:

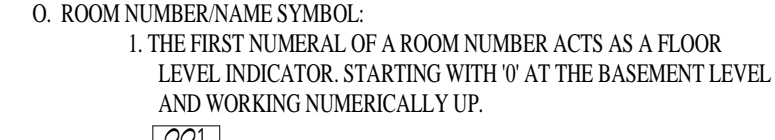


Q. WALL PARTITION TYPE SYMBOL: (SEE WALL PARTITION TYPES)

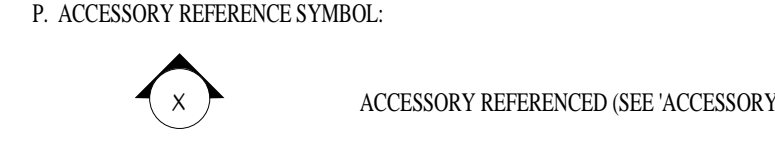


R. REVISIONS SYMBOLS:

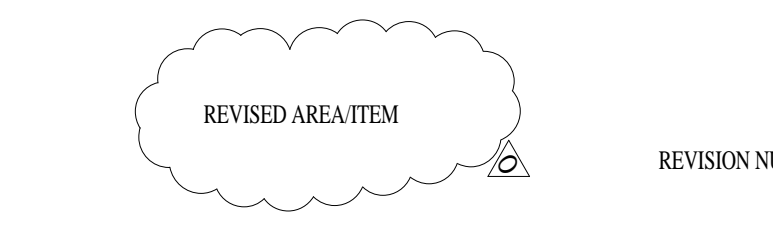


S. DETAIL NOTE SYMBOL:

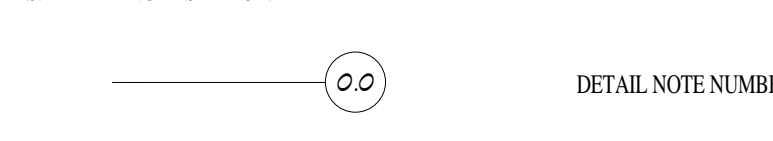


T. RATED WALL CONSTRUCTION SYMBOLS:

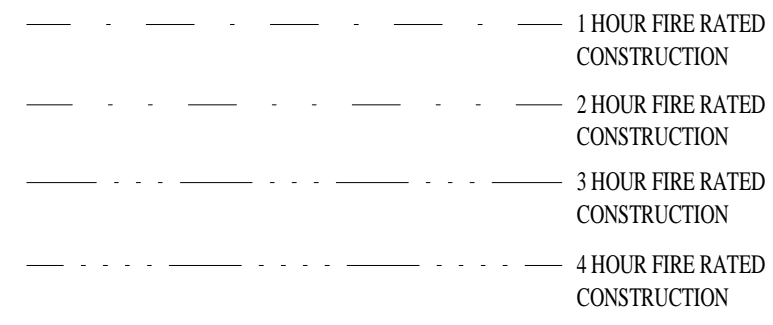

U. FIRE EXTINGUISHER IDENTIFICATION SYMBOLS:

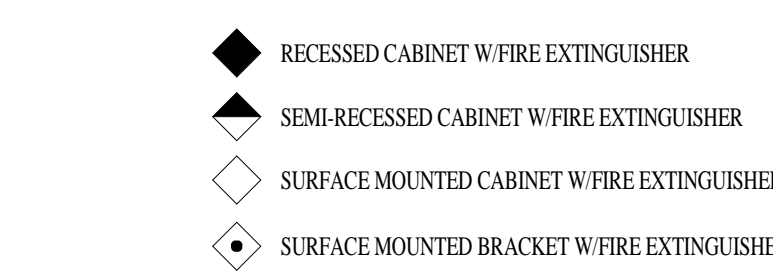

V. CEILING IDENTIFICATION SYMBOLS:

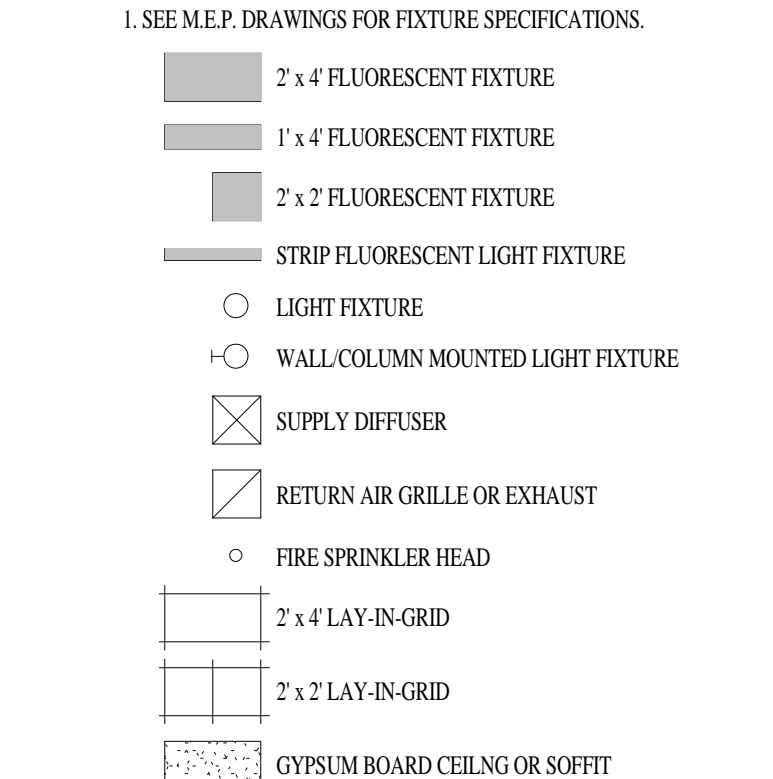

W. CEILING REFERENCE SYMBOLS:





GENERAL NOTES:


1. NONE TO ALL OF THE LISTED CRITERIA, SYMBOLS, ETC. MAY OR MAY NOT BE USED IN THIS SET OF CONSTRUCTION DOCUMENTS.
2. THE CONTRACTOR IS RESPONSIBLE FOR PRODUCING WEATHER-TIGHT CONSTRUCTION, DETAILS AND OMISSIONS TO THE DRAWINGS NOTWITHSTANDING.
3. ALL FINISH COLORS, TEXTURE, AND PATTERNS TO BE SELECTED BY THE ARCHITECT AND APPROVED PRIOR TO INSTALLATION.
4. ANY PIPE OR CONDUIT PENETRATION THRU EXTERIOR CONSTRUCTION SHALL BE SEALED AT BOTH SIDES FOR A WATER-TIGHT CONDITION, OR FOR FIRE STOP ASSEMBLIES THROUGH RATED WALLS.
5. ALL FLOORS WITH DRAINS SHALL HAVE A MINIMUM OF 1/8" PER FOOT SLOPE TO DRAIN, U.N.O.
6. CONTRACTOR SHALL INVESTIGATE, VERIFY, AND BE RESPONSIBLE FOR ALL EXISTING CONDITIONS AND NEW DIMENSIONS OF THE PROJECT AND CONFORM SUCH TO BE APPROPRIATE AND COMPATIBLE WITH NEW CONSTRUCTION. THE CONTRACTOR SHALL NOTIFY THE ARCHITECT OF ANY DISCREPANCY FOR CLARIFICATION OR ABOUT ANY CONDITION REQUIRING MODIFICATION OR CHANGE BEFORE PROCEEDING WITH THE WORK.
7. ALL EXPOSED C.M.U. CORNERS TO BE BULL NOSE. COORDINATE EXCEPTIONS WITH ARCHITECT.

DETAIL NOTES:

TOILET ACCESSORIES KEY:

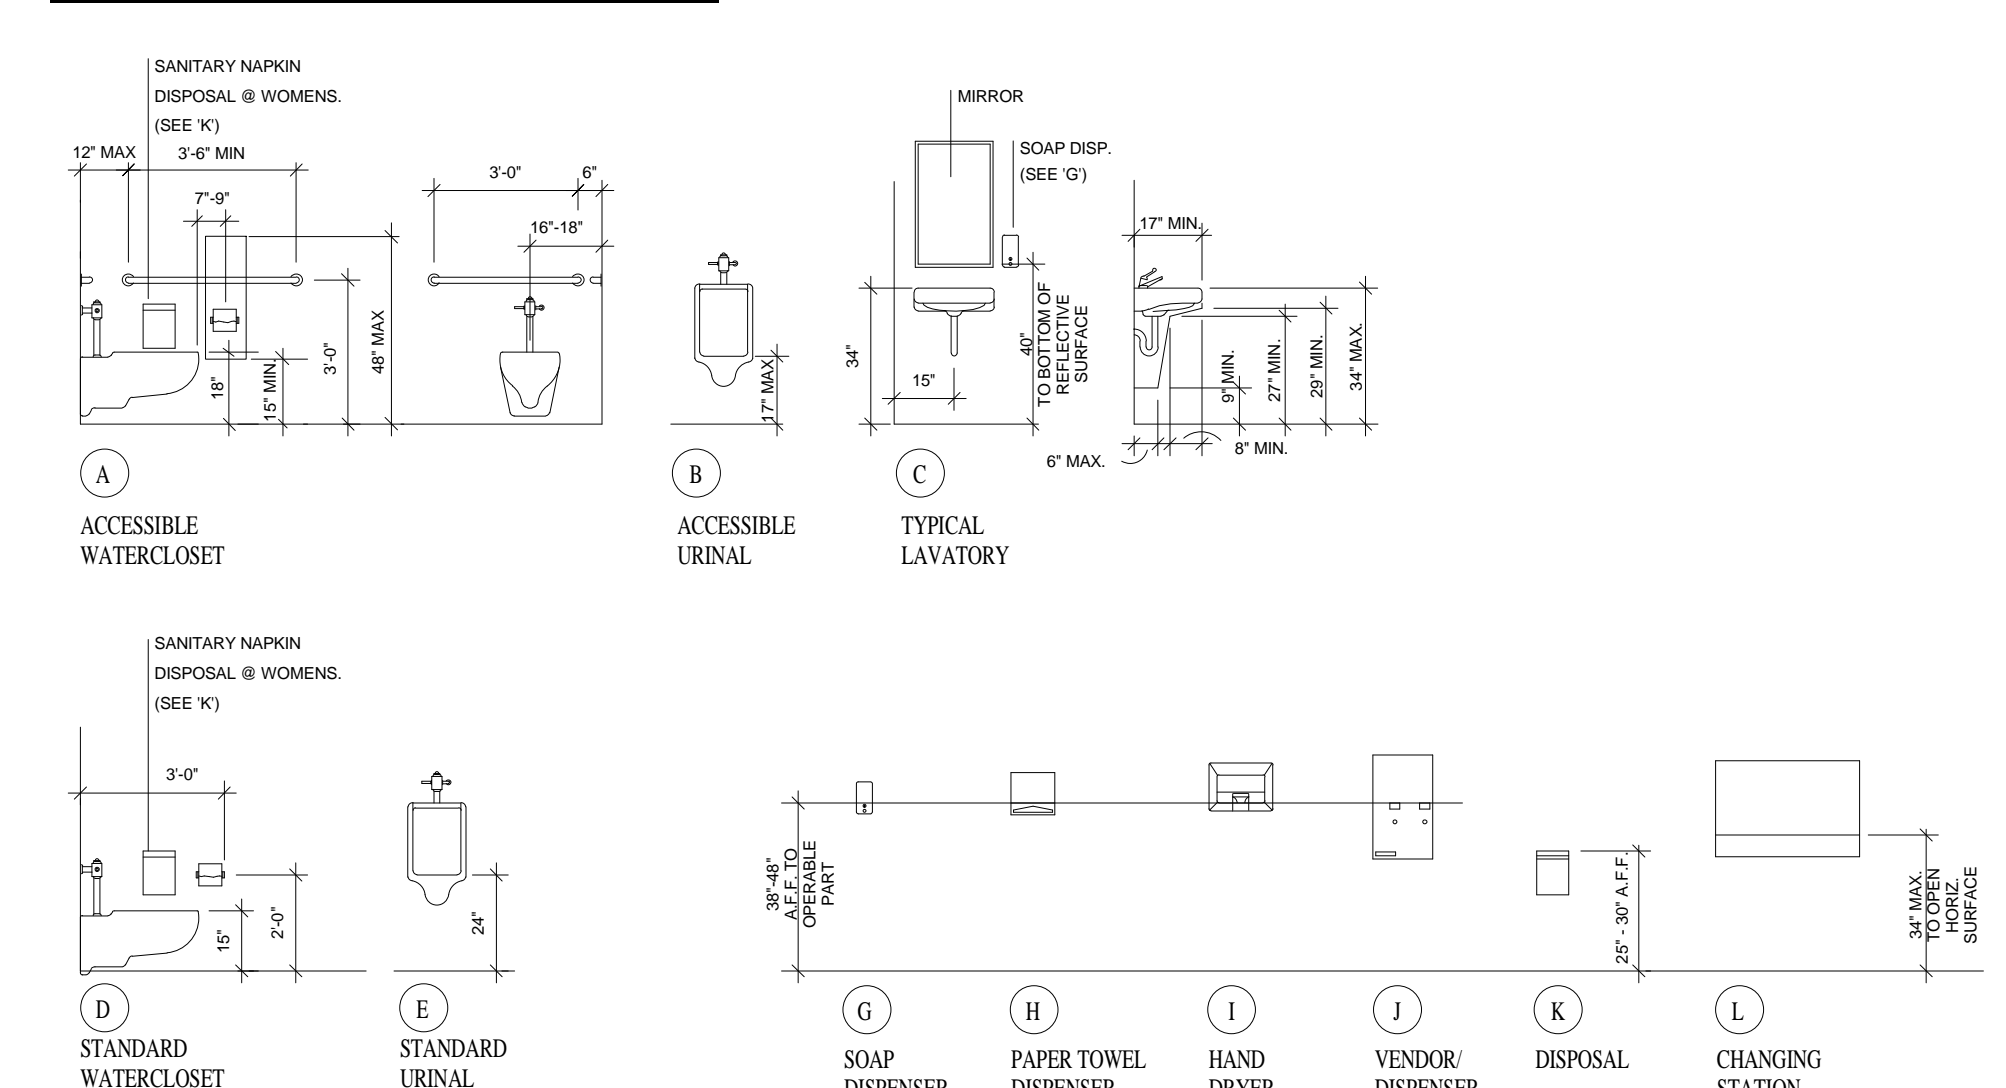

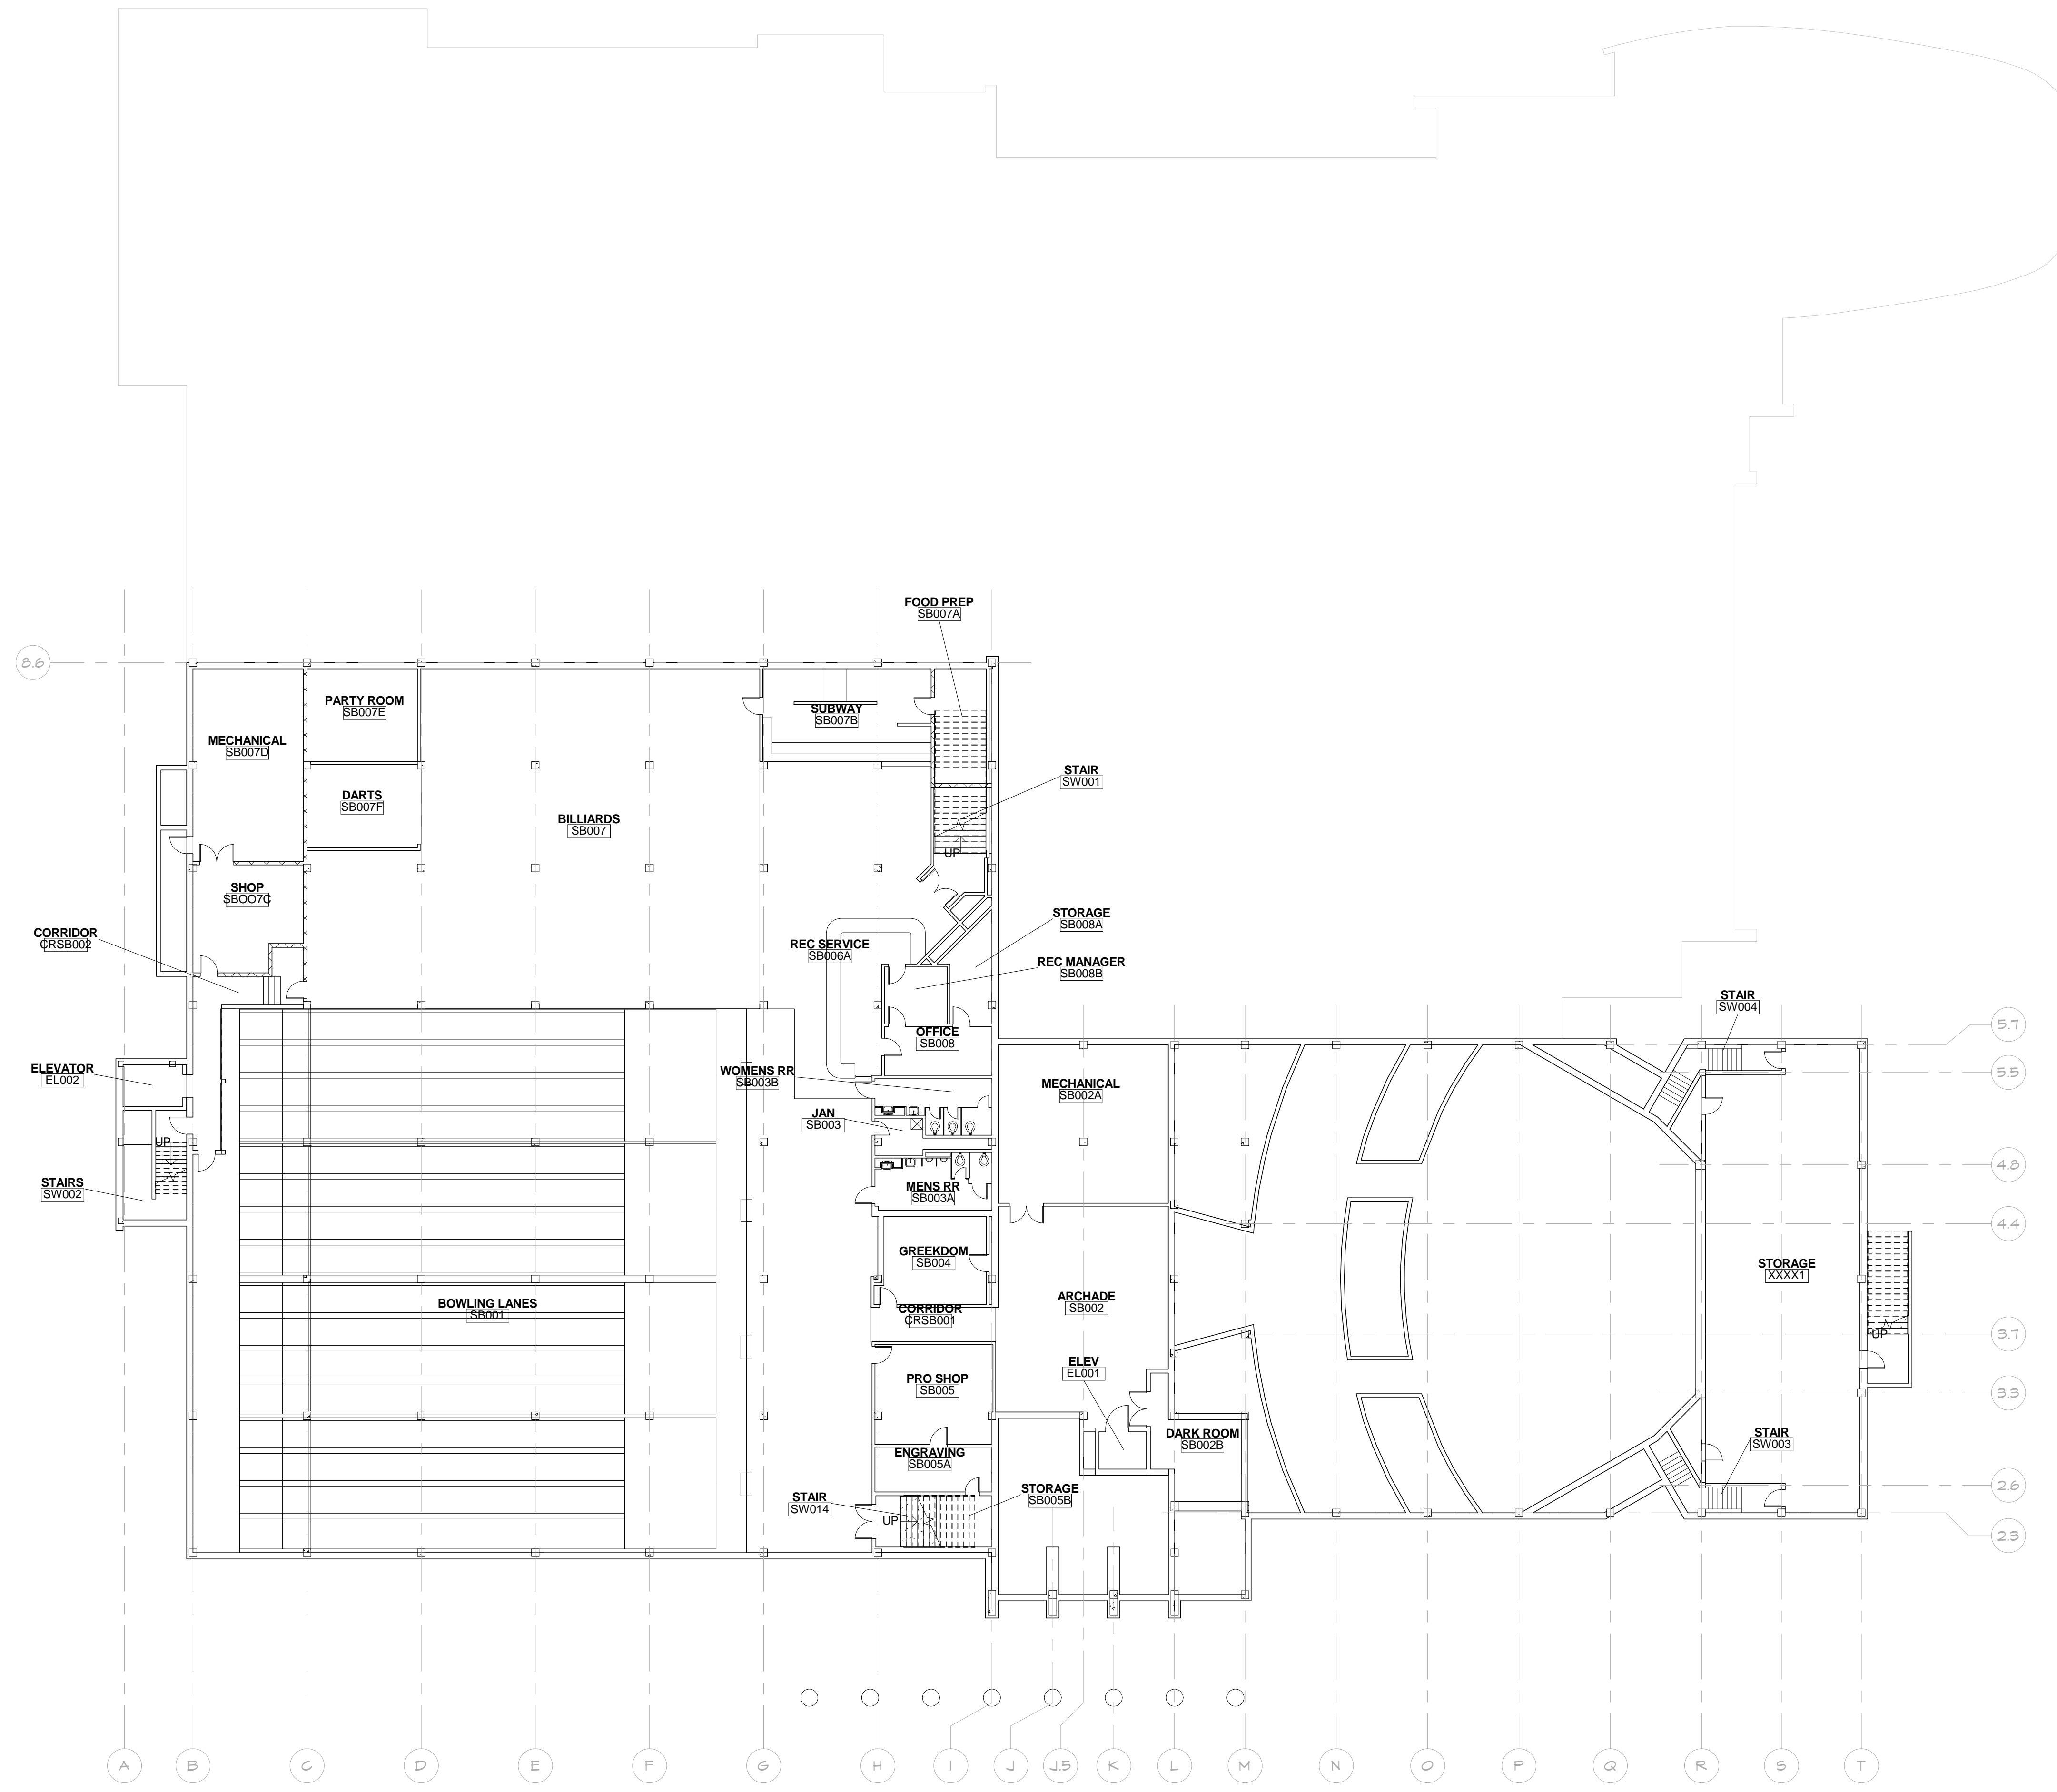

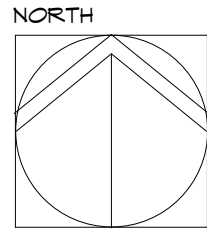NORTH

LOWER LEVEL
 1/16" = 1'-0"

PROGRESS DOCUMENT
 NOT FOR CONSTRUCTION

KSU DWG NO.
 DR 2014-XXX

SHEET
 OF

TOTAL SHEETS IN SET
 XXX

Department of Administration
 Management
 Office
 Landrum Street Office Building
 800 SW Jackson, Suite 700
 Topeka, Kansas 66612-1216
 Phone 785-296-8899
 Fax 785-296-8898


KANSAS STATE UNIVERSITY
STUDENT UNION RENOVATION
 CCSU STUDENT UNION- MANHATTAN, KS 66502
 BUILDING NUMBER 36700-00101
 DATE: Issue Date
 BY: DC
 CHECKED BY: BB
 REV.: No


LOWER LEVEL-EXISTING

A-012552

A002

SCHEMATIC DESIGN

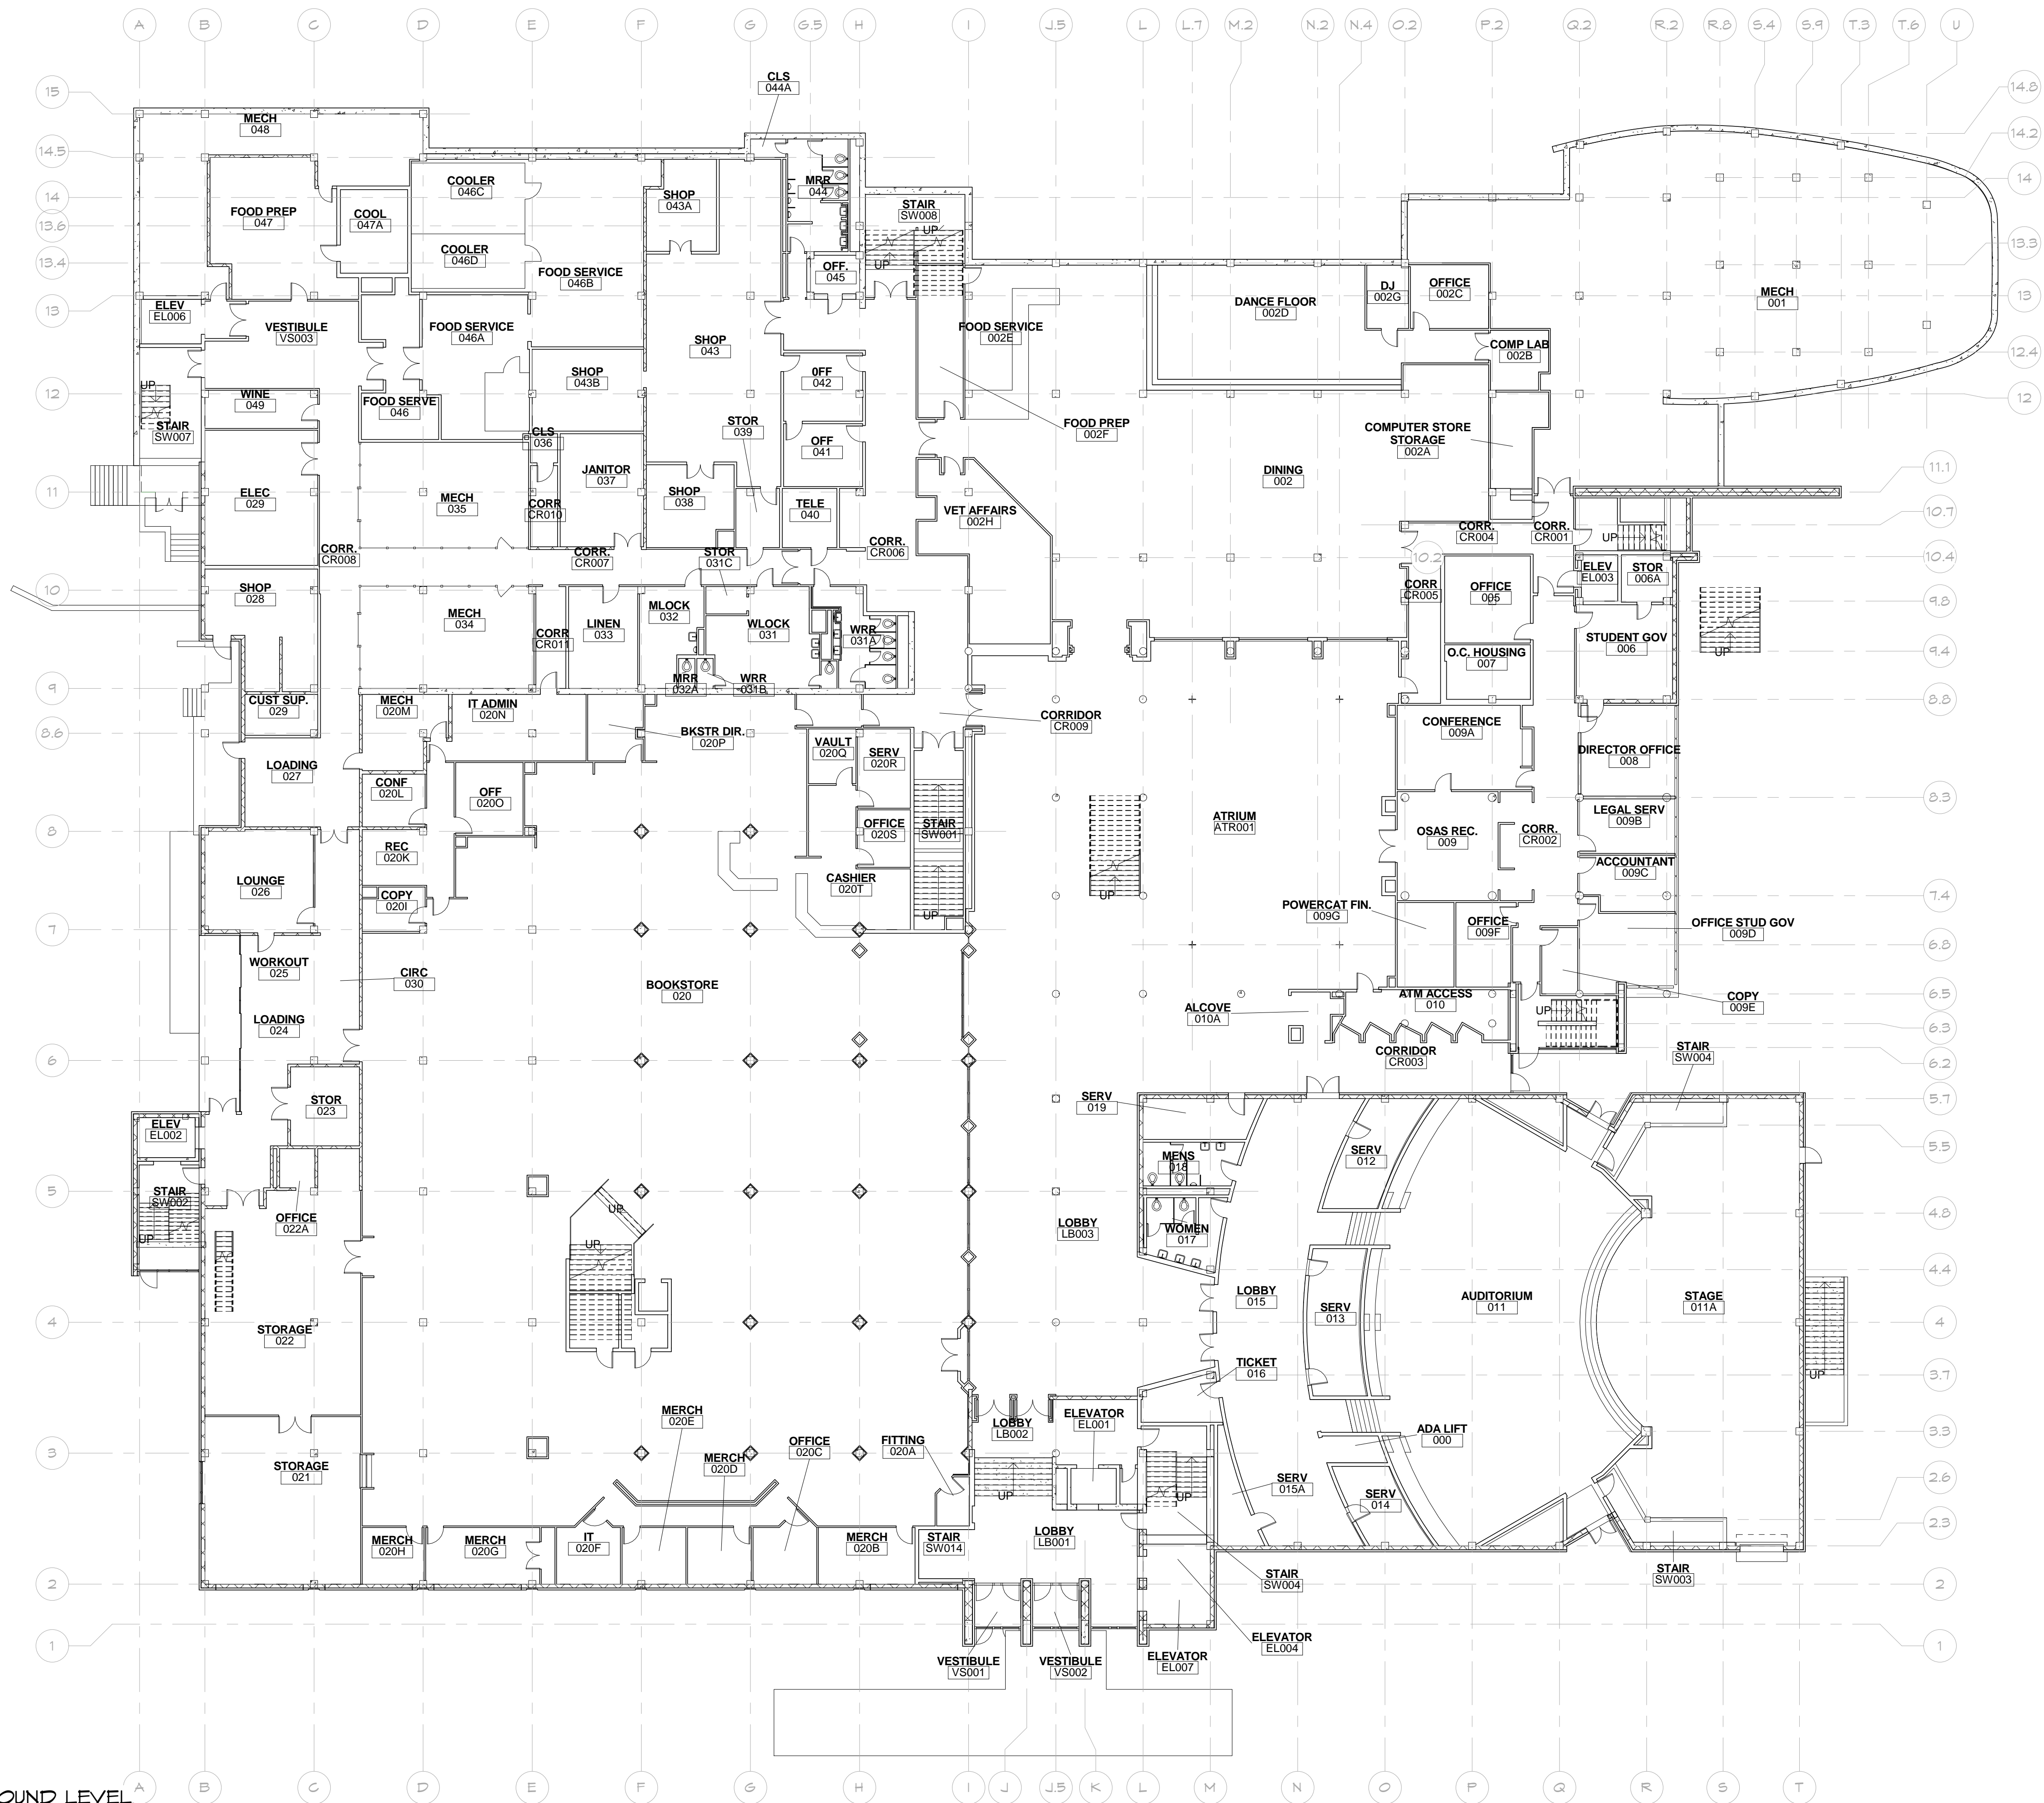

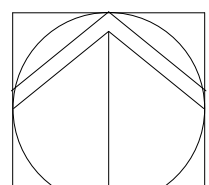NORTH

GROUND LEVEL
 1/16" = 1'-0"

PROGRESS DOCUMENT
 NOT FOR CONSTRUCTION

KSU DWG NO.
 DR 2014-XXX

SHEET
 OF

TOTAL SHEETS IN SET
 XXX

Department of Administration
 Office of Administration Management
 800 SW Jackson, Suite 700
 Topeka, Kansas 66612-1216
 Phone 785-296-9899
 Fax 785-296-9898


KANSAS STATE UNIVERSITY
 STUDENT UNION RENOVATION
 KSU STUDENT UNION - MANHATTAN, KS 66502
 BUILDING NUMBER 36700-00101
 DATE: Issue Date
 BY: Author CHECKED BY: Checker REV: No

GROUND
 LEVEL-EXISTING

A-012552

A003

SCHEMATIC DESIGN

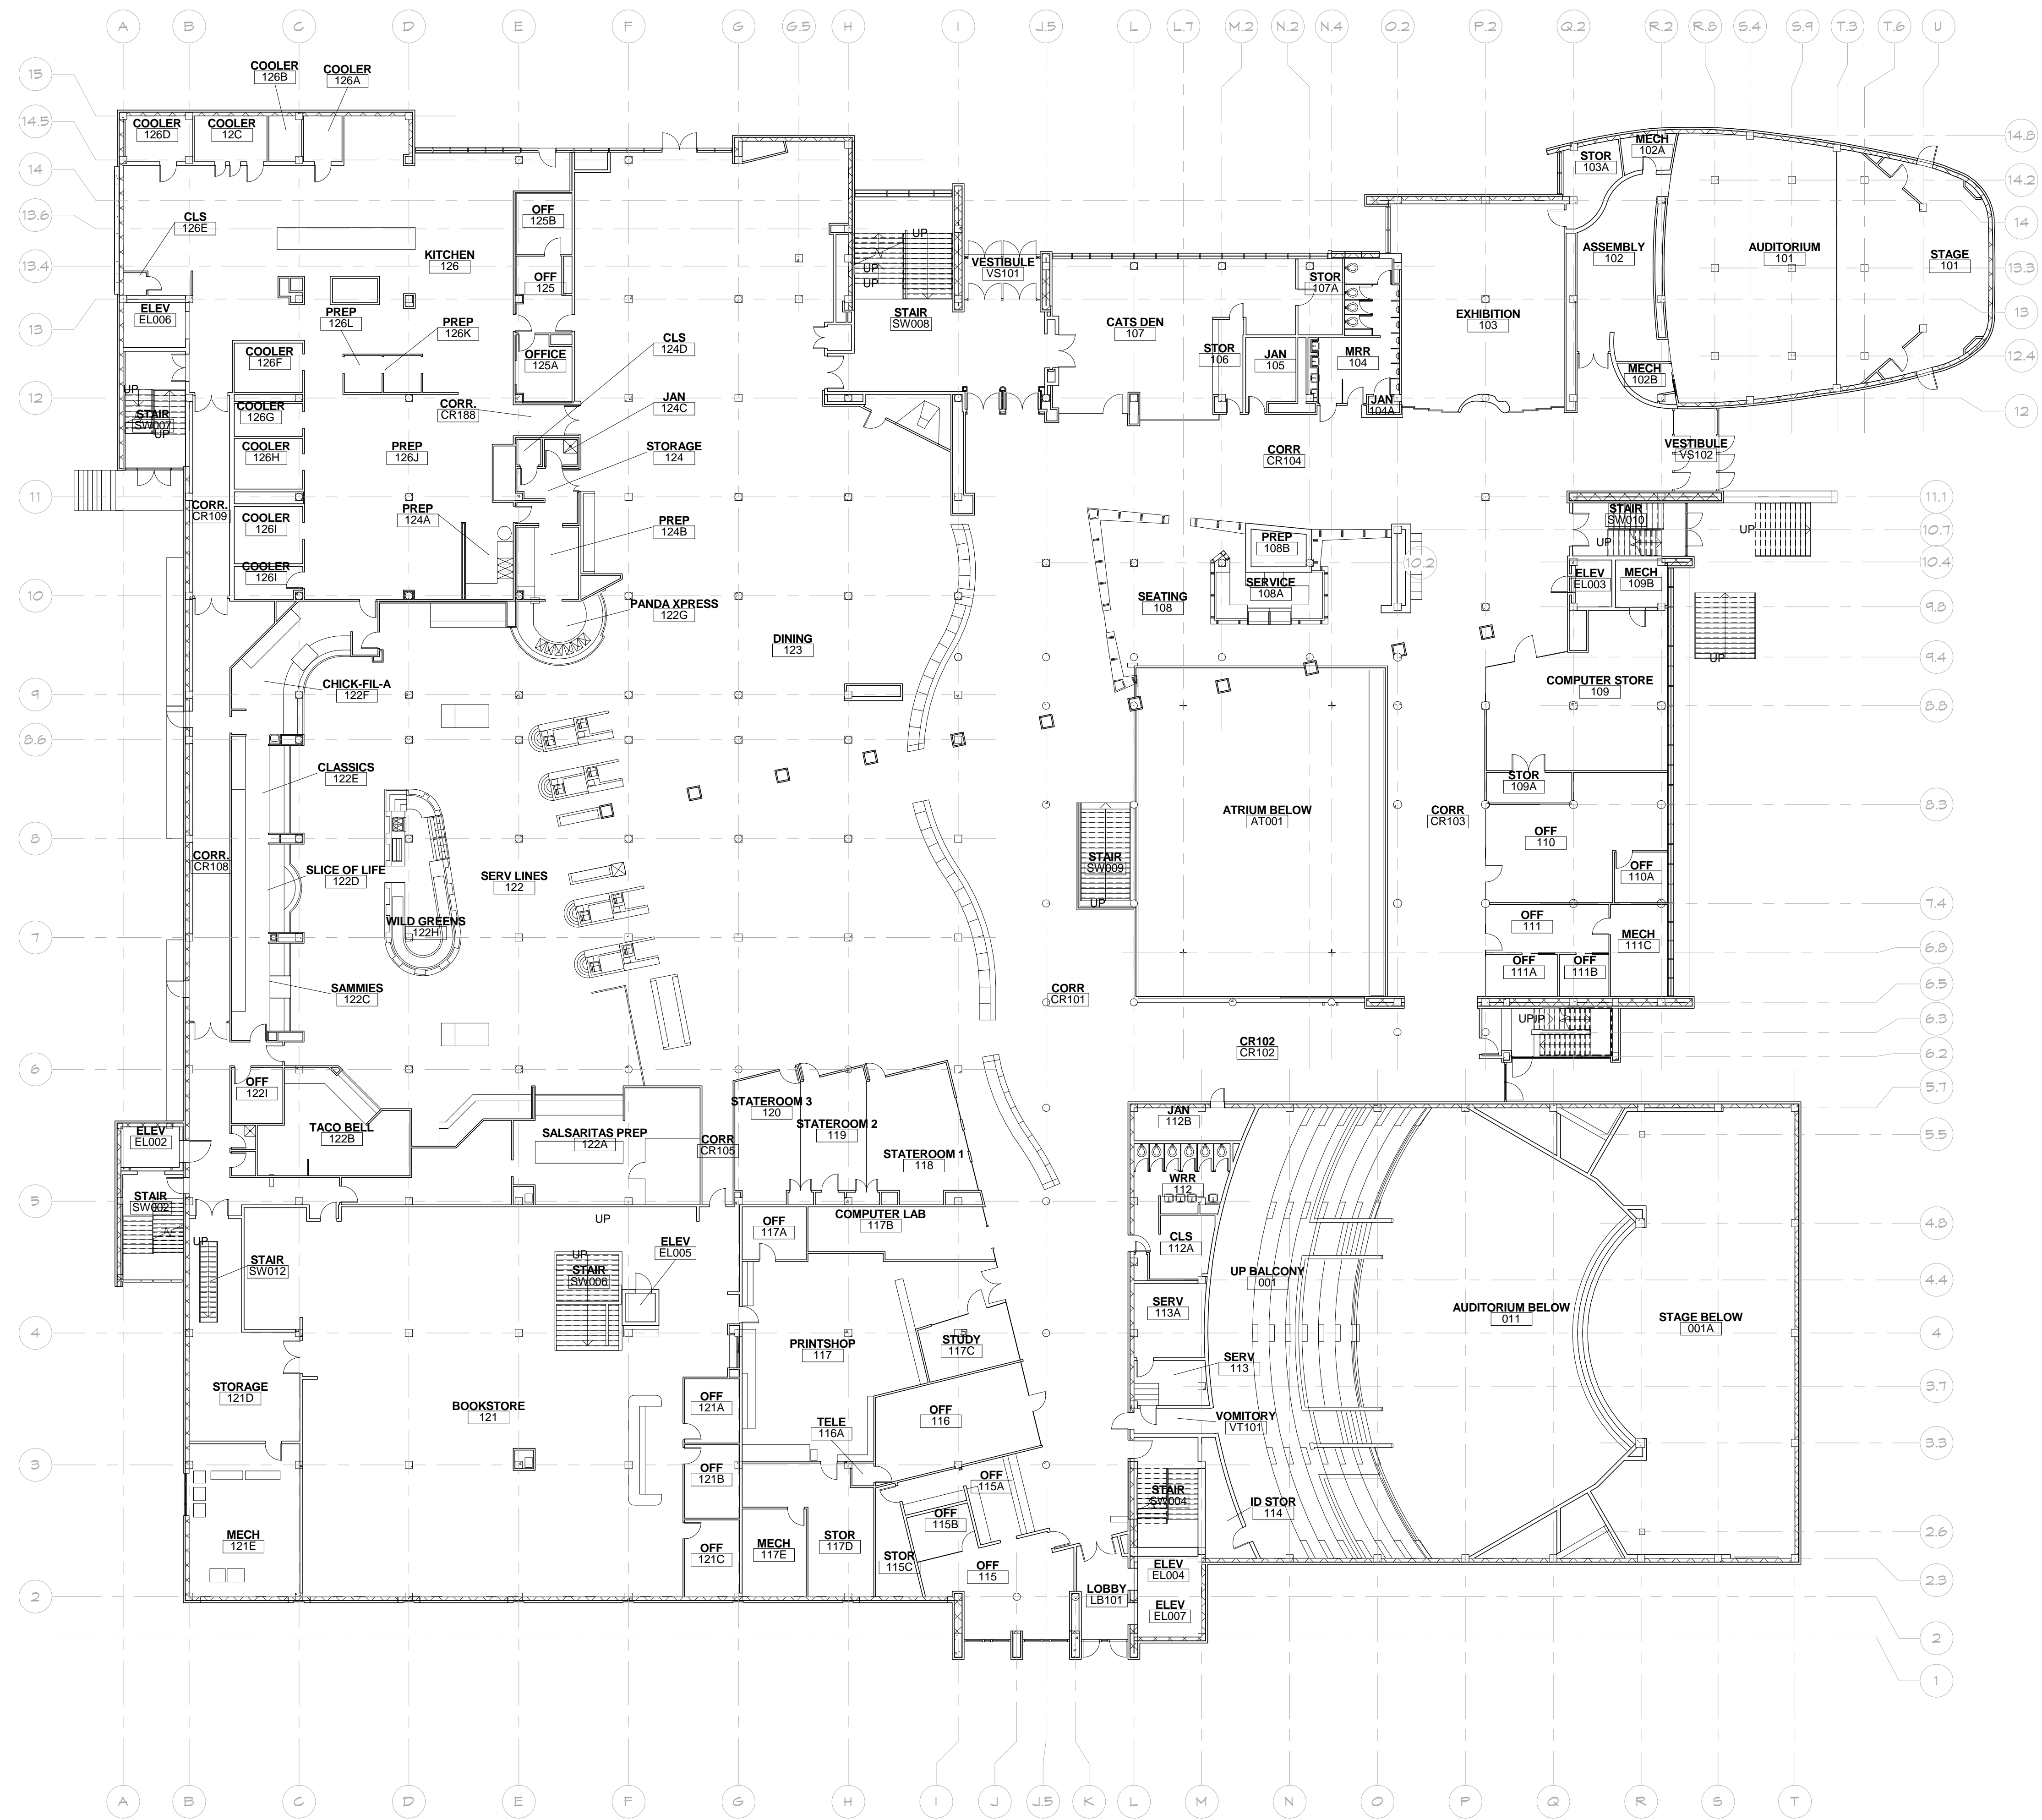

1 FIRST LEVEL
 1/16" = 1'-0"

PROGRESS DOCUMENT
 NOT FOR CONSTRUCTION

KSU DWG NO.
 DR 2014-XXX

SHEET
 OF

TOTAL SHEETS IN SET
 XXX

Department of Administration
 Office of Administration
 800 SW Jackson, Suite 700
 Topeka, Kansas 66612-1216
 Phone 785-296-8899
 Fax 785-296-8898



KANSAS STATE UNIVERSITY
STUDENT UNION RENOVATION
 KSU STUDENT UNION - MANHATTAN, KS 66502
 BUILDING NUMBER 36700-00101
 BY: Author CHECKED BY: Checker REV: No
 DATE: Issue Date

FIRST LEVEL-EXISTING

A-012552

A004

SCHEMATIC DESIGN

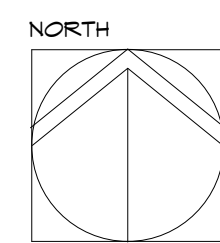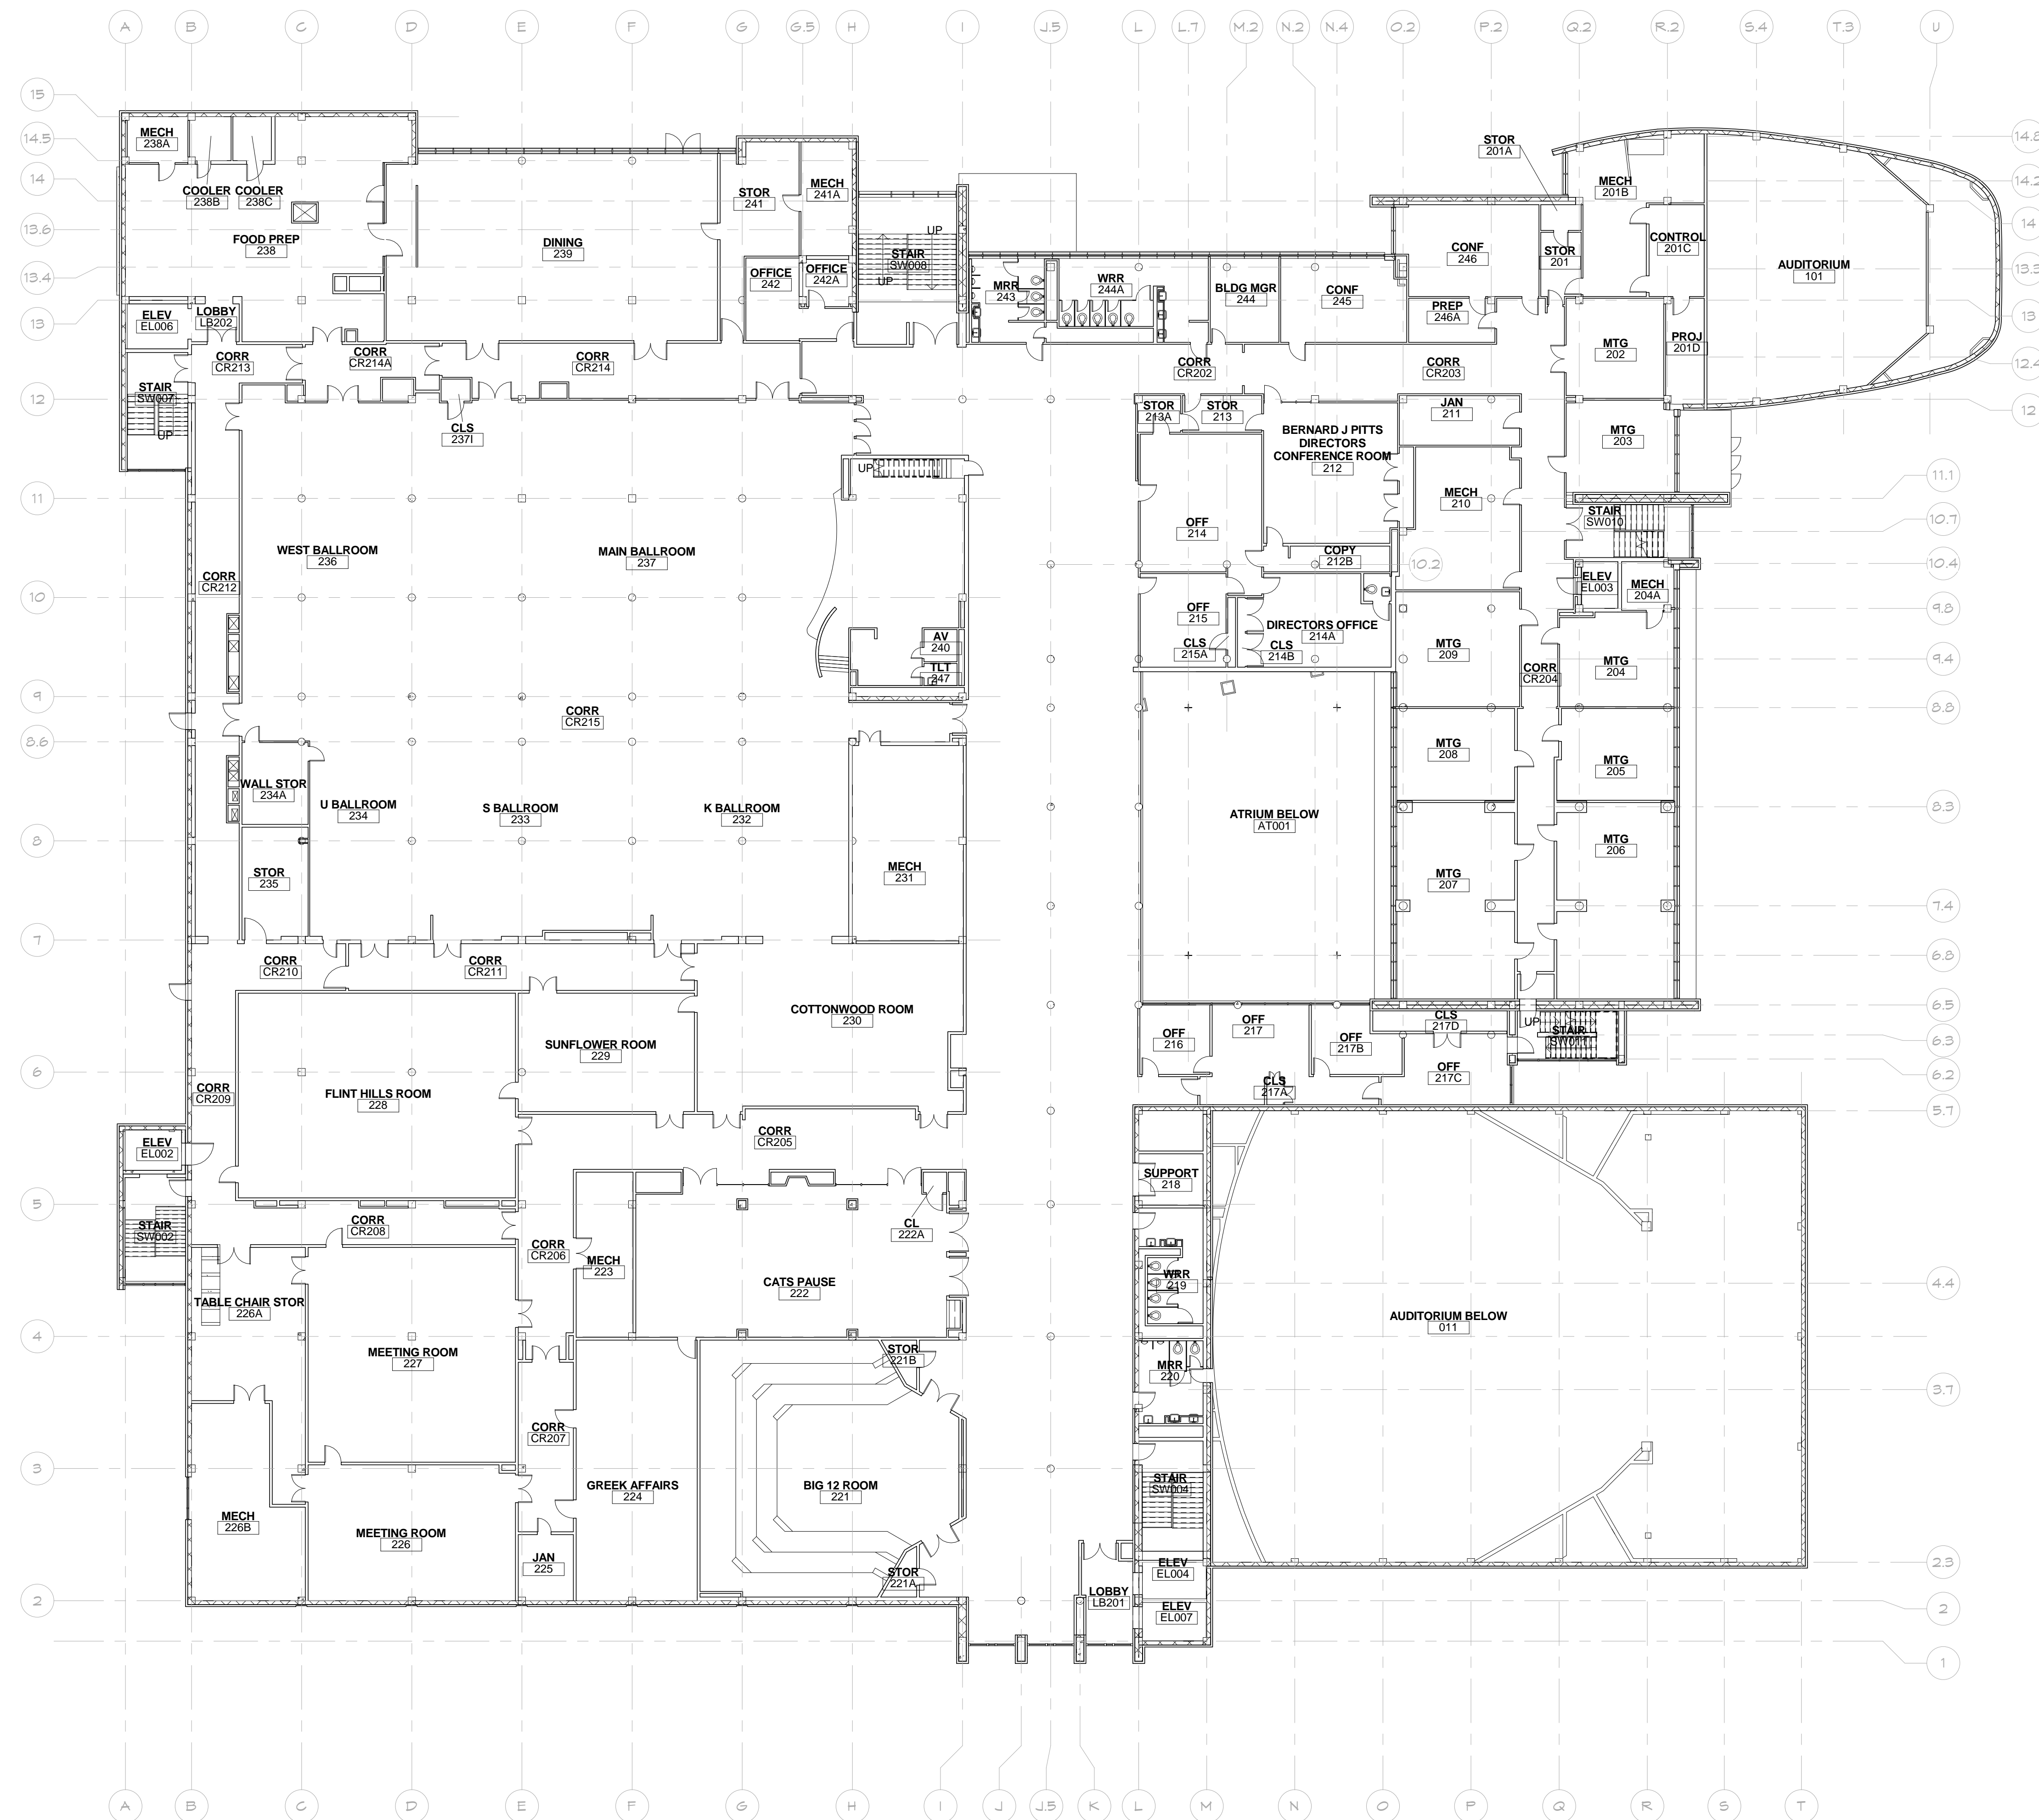

SECOND LEVEL
1/16" = 1'-0"

PROGRESS DOCUMENT
 NOT FOR CONSTRUCTION

KSU DWG NO.
DR 2014-XXX

SHEET
OF

TOTAL SHEETS IN SET
XXX

Department of Administration
Office of Administration
Landon Street Office Building
800 SW Jackson, Suite 700
Topeka, Kansas 66612-1216
Phone 785-296-9899
Fax 785-296-9898


KANSAS STATE UNIVERSITY
 STUDENT UNION RENOVATION
 KSU STUDENT UNION- MANHATTAN, KS 66502
 BUILDING NUMBER 36700-00101
 DATE: Issue
 Date


SECOND
LEVEL-EXISTING

A-012552

A005

SCHEMATIC DESIGN

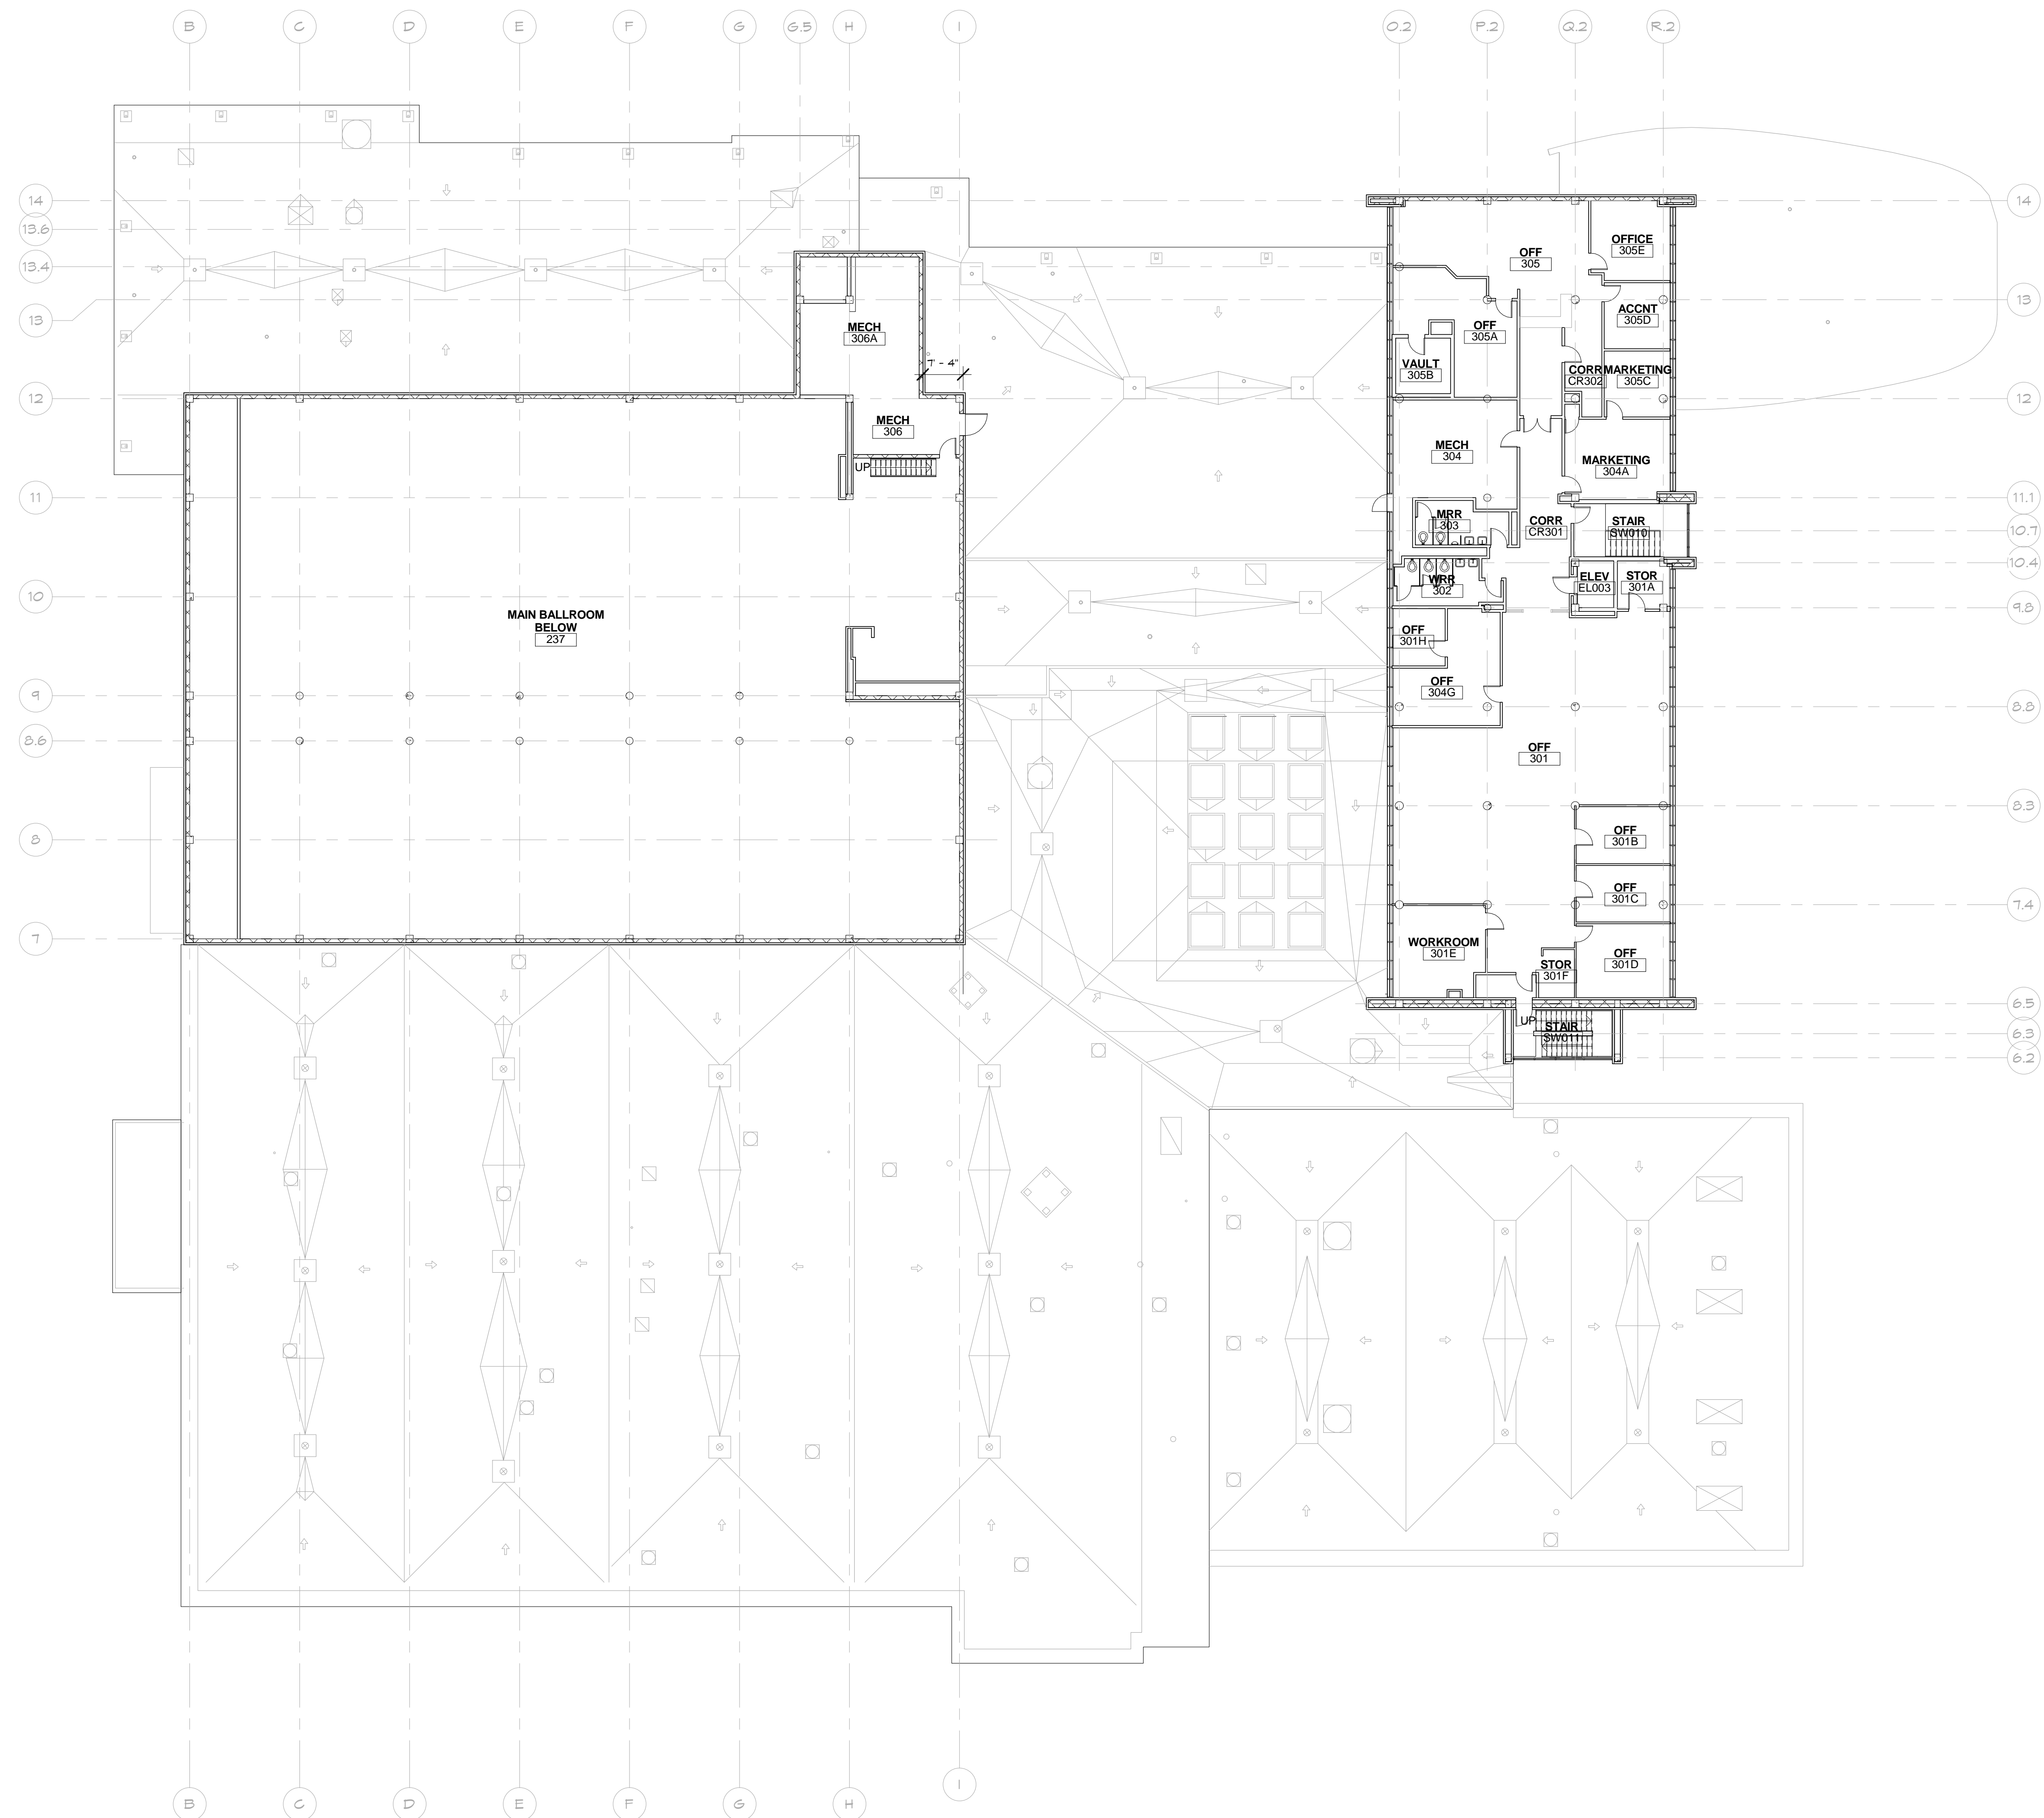

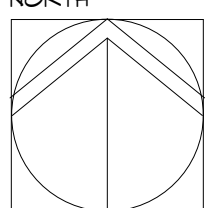NORTH

THIRD LEVEL
 1/16" = 1'-0"

PROGRESS DOCUMENT
 NOT FOR CONSTRUCTION

KSU DWG NO.
 DR 2014-XXX

SHEET
 OF

TOTAL SHEETS IN SET
 XXX

Department of Administration
 Office of Construction Management
 800 SW Jackson, Suite 700
 Topeka, Kansas 66612-1216
 Phone 785-296-8899
 Fax 785-296-8898



KANSAS STATE UNIVERSITY
STUDENT UNION RENOVATION
 CCSU STUDENT UNION - MANHATTAN, KS 66502
 BUILDING NUMBER 36700-00101
 DATE: Issue
 Date
 BY: Author
 CHECKED BY: Checker
 REV: No

THIRD LEVEL-EXISTING

A-012552

A006

SCHEMATIC DESIGN

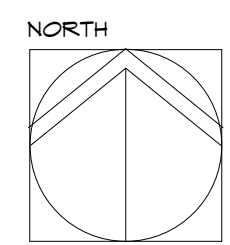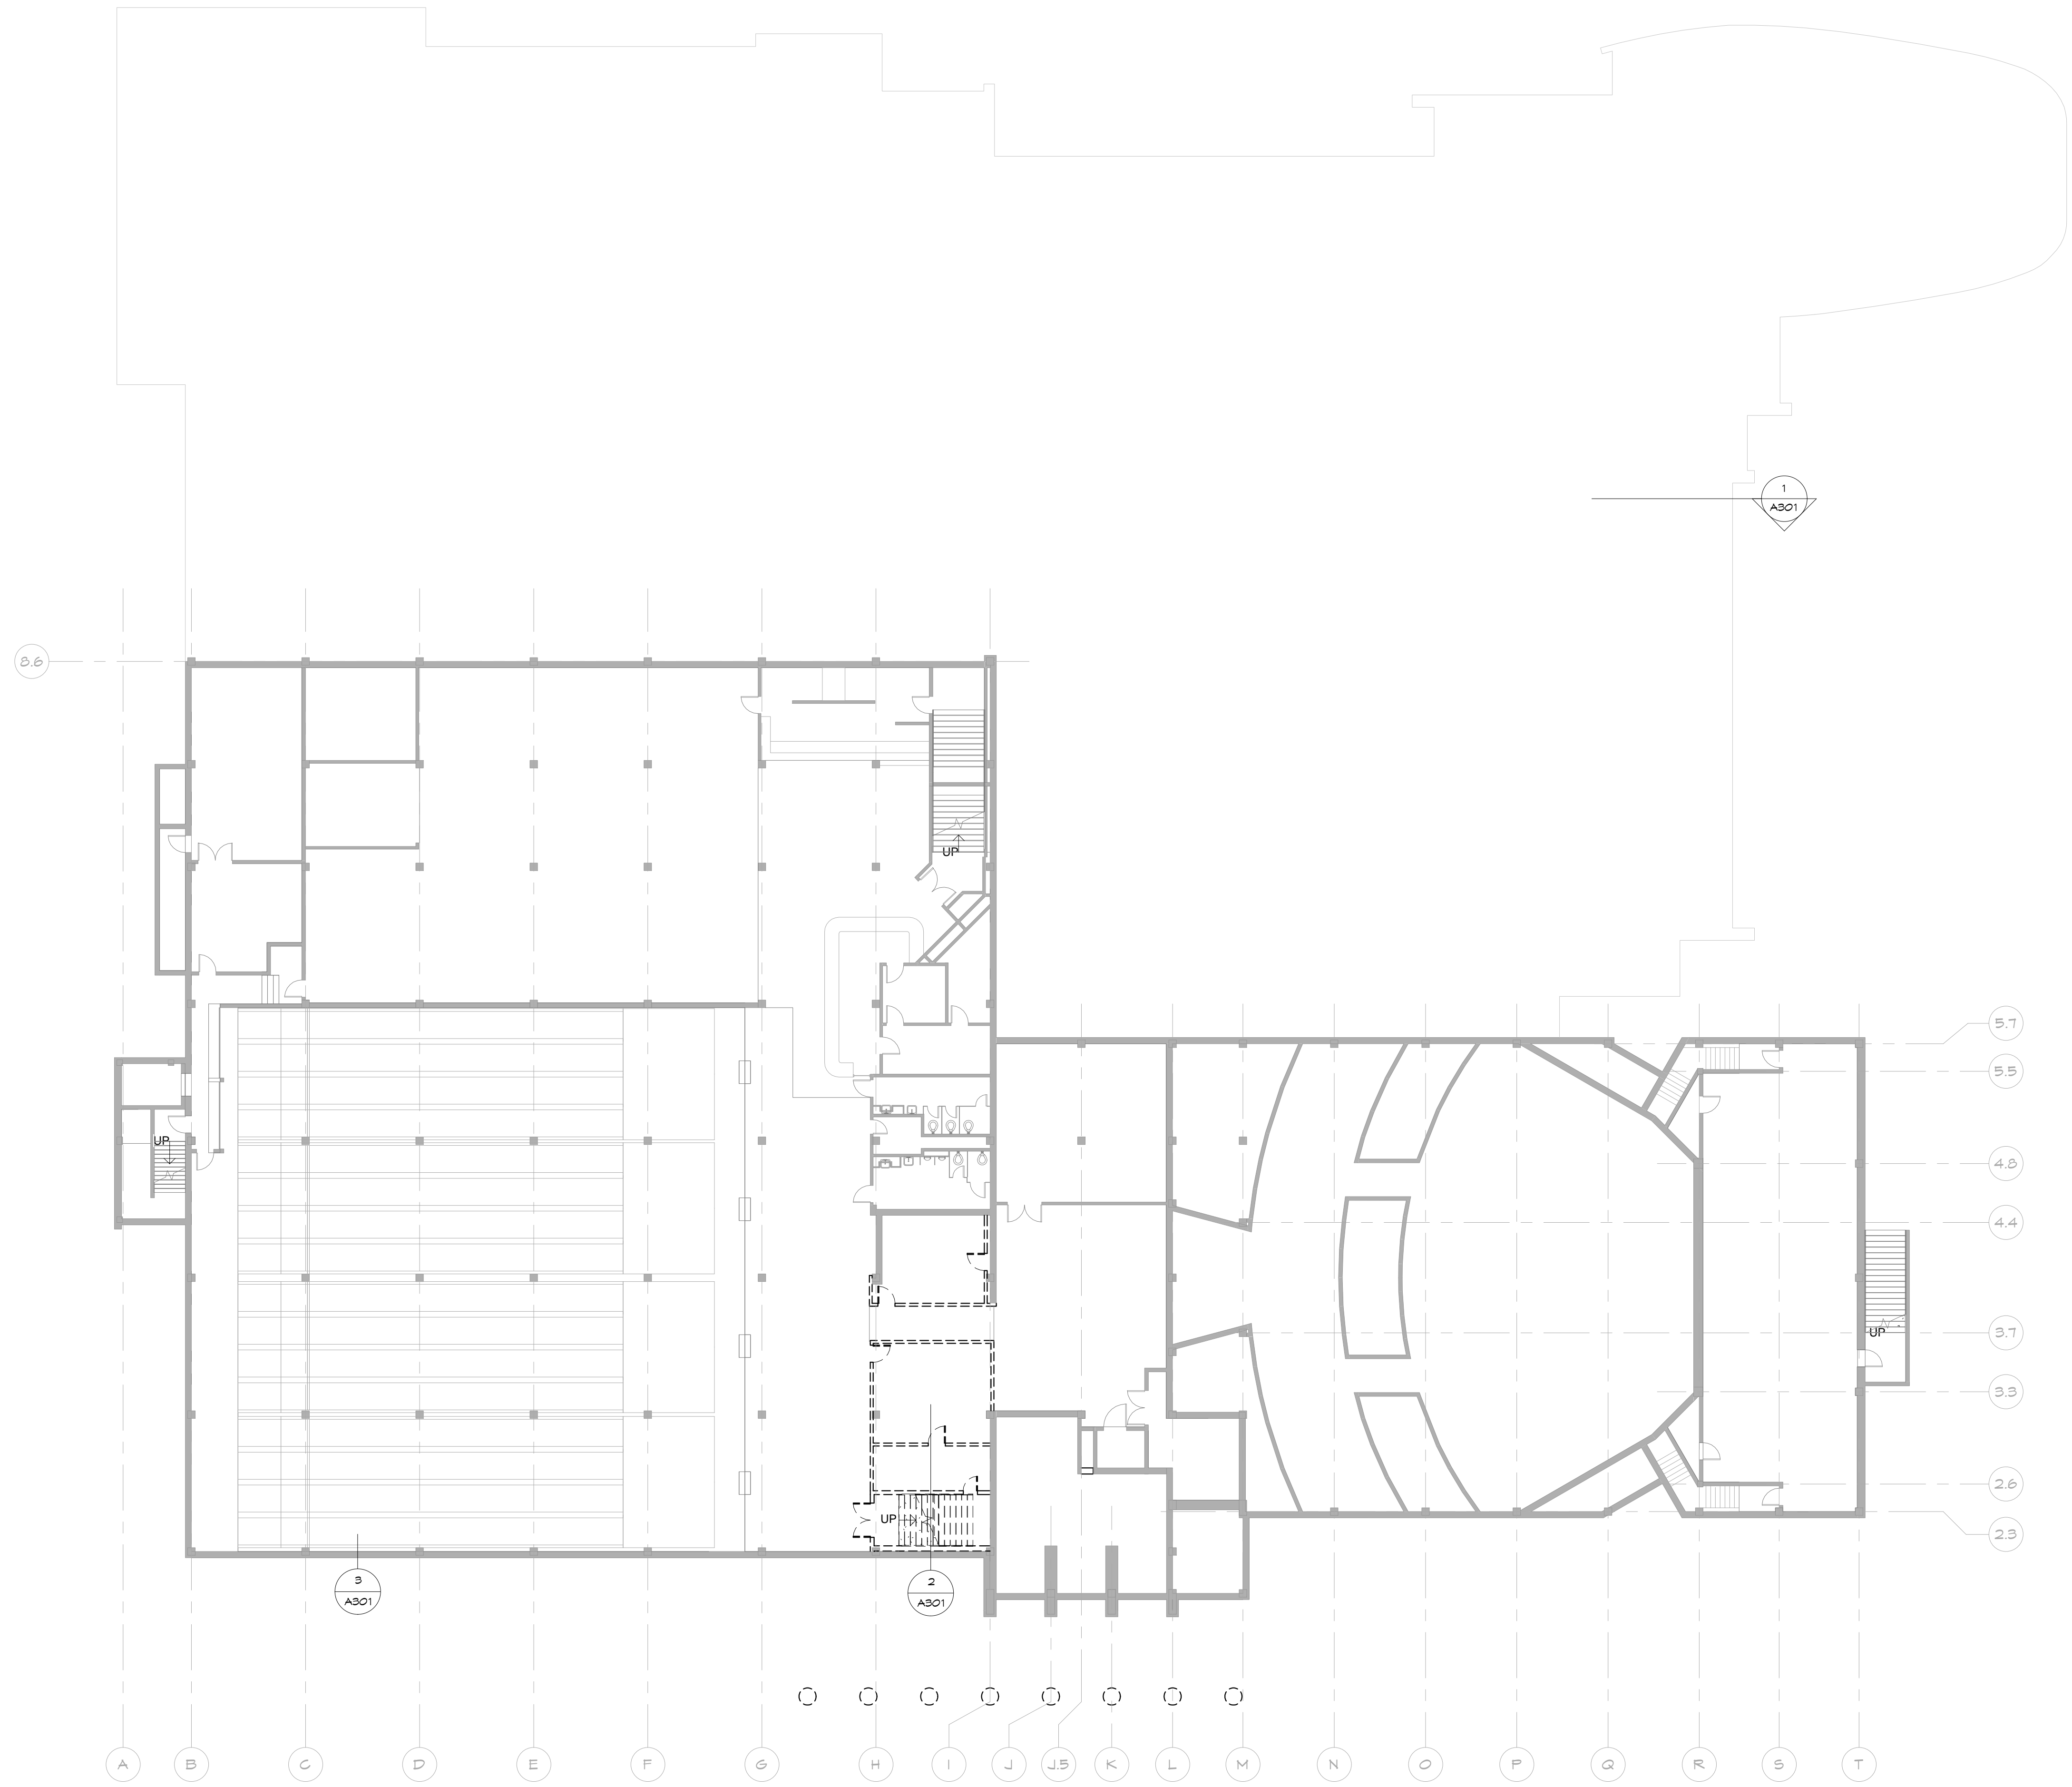

LOWER LEVEL-DEMOLITION
1/16" = 1'-0"

PROGRESS DOCUMENT
NOT FOR CONSTRUCTION

KSU DWG NO.
DR 2014-XXX

SHEET
OF

TOTAL SHEETS IN SET
XXX

Department of Administration
Office of Landmarks Management
Landmark Office Building
800 SW Jackson, Suite 700
Topeka, Kansas 66612-1216
Phone 785-236-8899
Fax 785-296-8888



KANSAS STATE UNIVERSITY
STUDENT UNION RENOVATION
KSU STUDENT UNION- MANHATTAN, KS 66502
BUILDING NUMBER 36700-00101
DATE: Issue _____
By: Author _____
Checked By: _____
Date _____

LOWER LEVEL-DEMOLITION PLAN

A-012552

A007

SCHEMATIC DESIGN

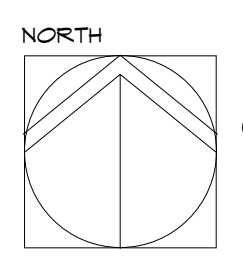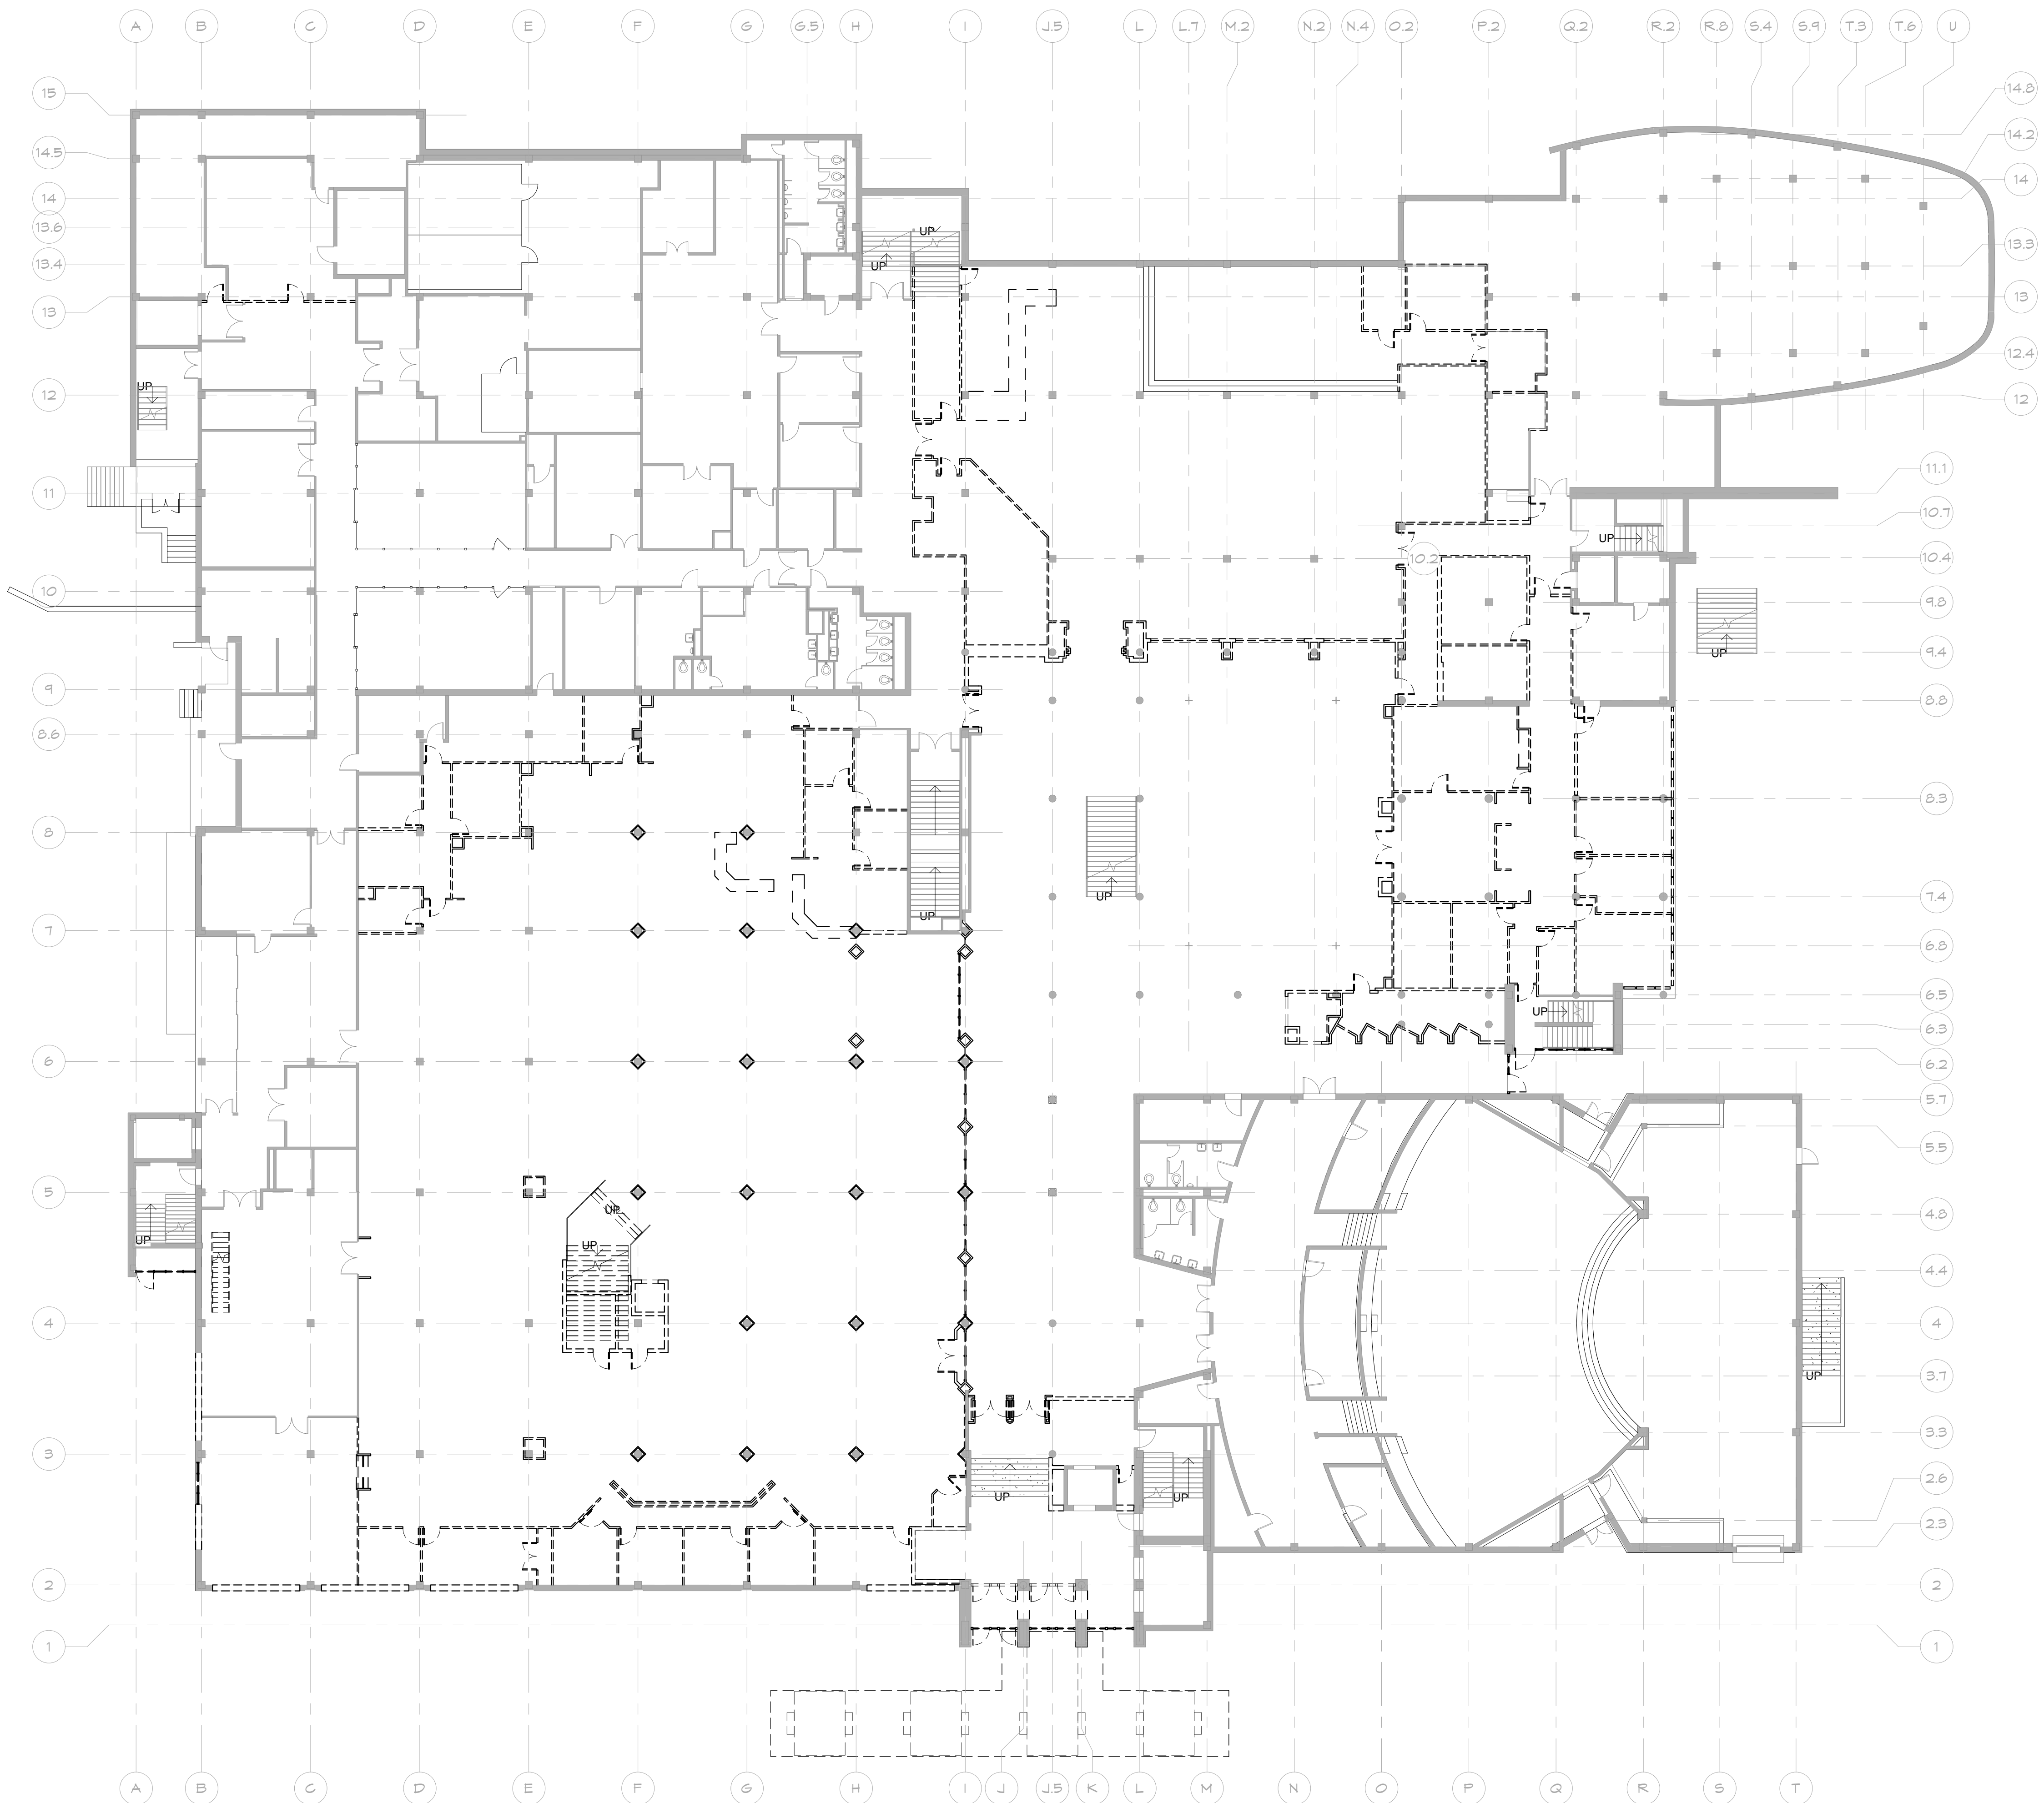

GROUND LEVEL-DEMOLITION
1/16" = 1'-0"

PROGRESS DOCUMENT NOT FOR CONSTRUCTION

KSU DWG NO.
DR 2014-XXX

SHEET
OF

TOTAL SHEETS IN SET
XXX

Department of Administration
Office of Construction Management
Landon Street Office Building
800 SW Jackson, Suite 700
Topeka, Kansas 66612-1216
Phone 785-296-8899
Fax 785-296-8898

PROGRESS DOCUMENT NOT FOR CONSTRUCTION

DATE: Issue
Date

GROUND LEVEL-DEMOLITION PLAN

A-012552



A008

SCHEMATIC DESIGN

KANSAS STATE UNIVERSITY STUDENT UNION RENOVATION

KSU STUDENT UNION- MANHATTAN, KS 66502
BUILDING NUMBER 36700-00101

BY: Author CHECKED BY: Checker REV: No

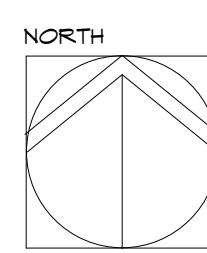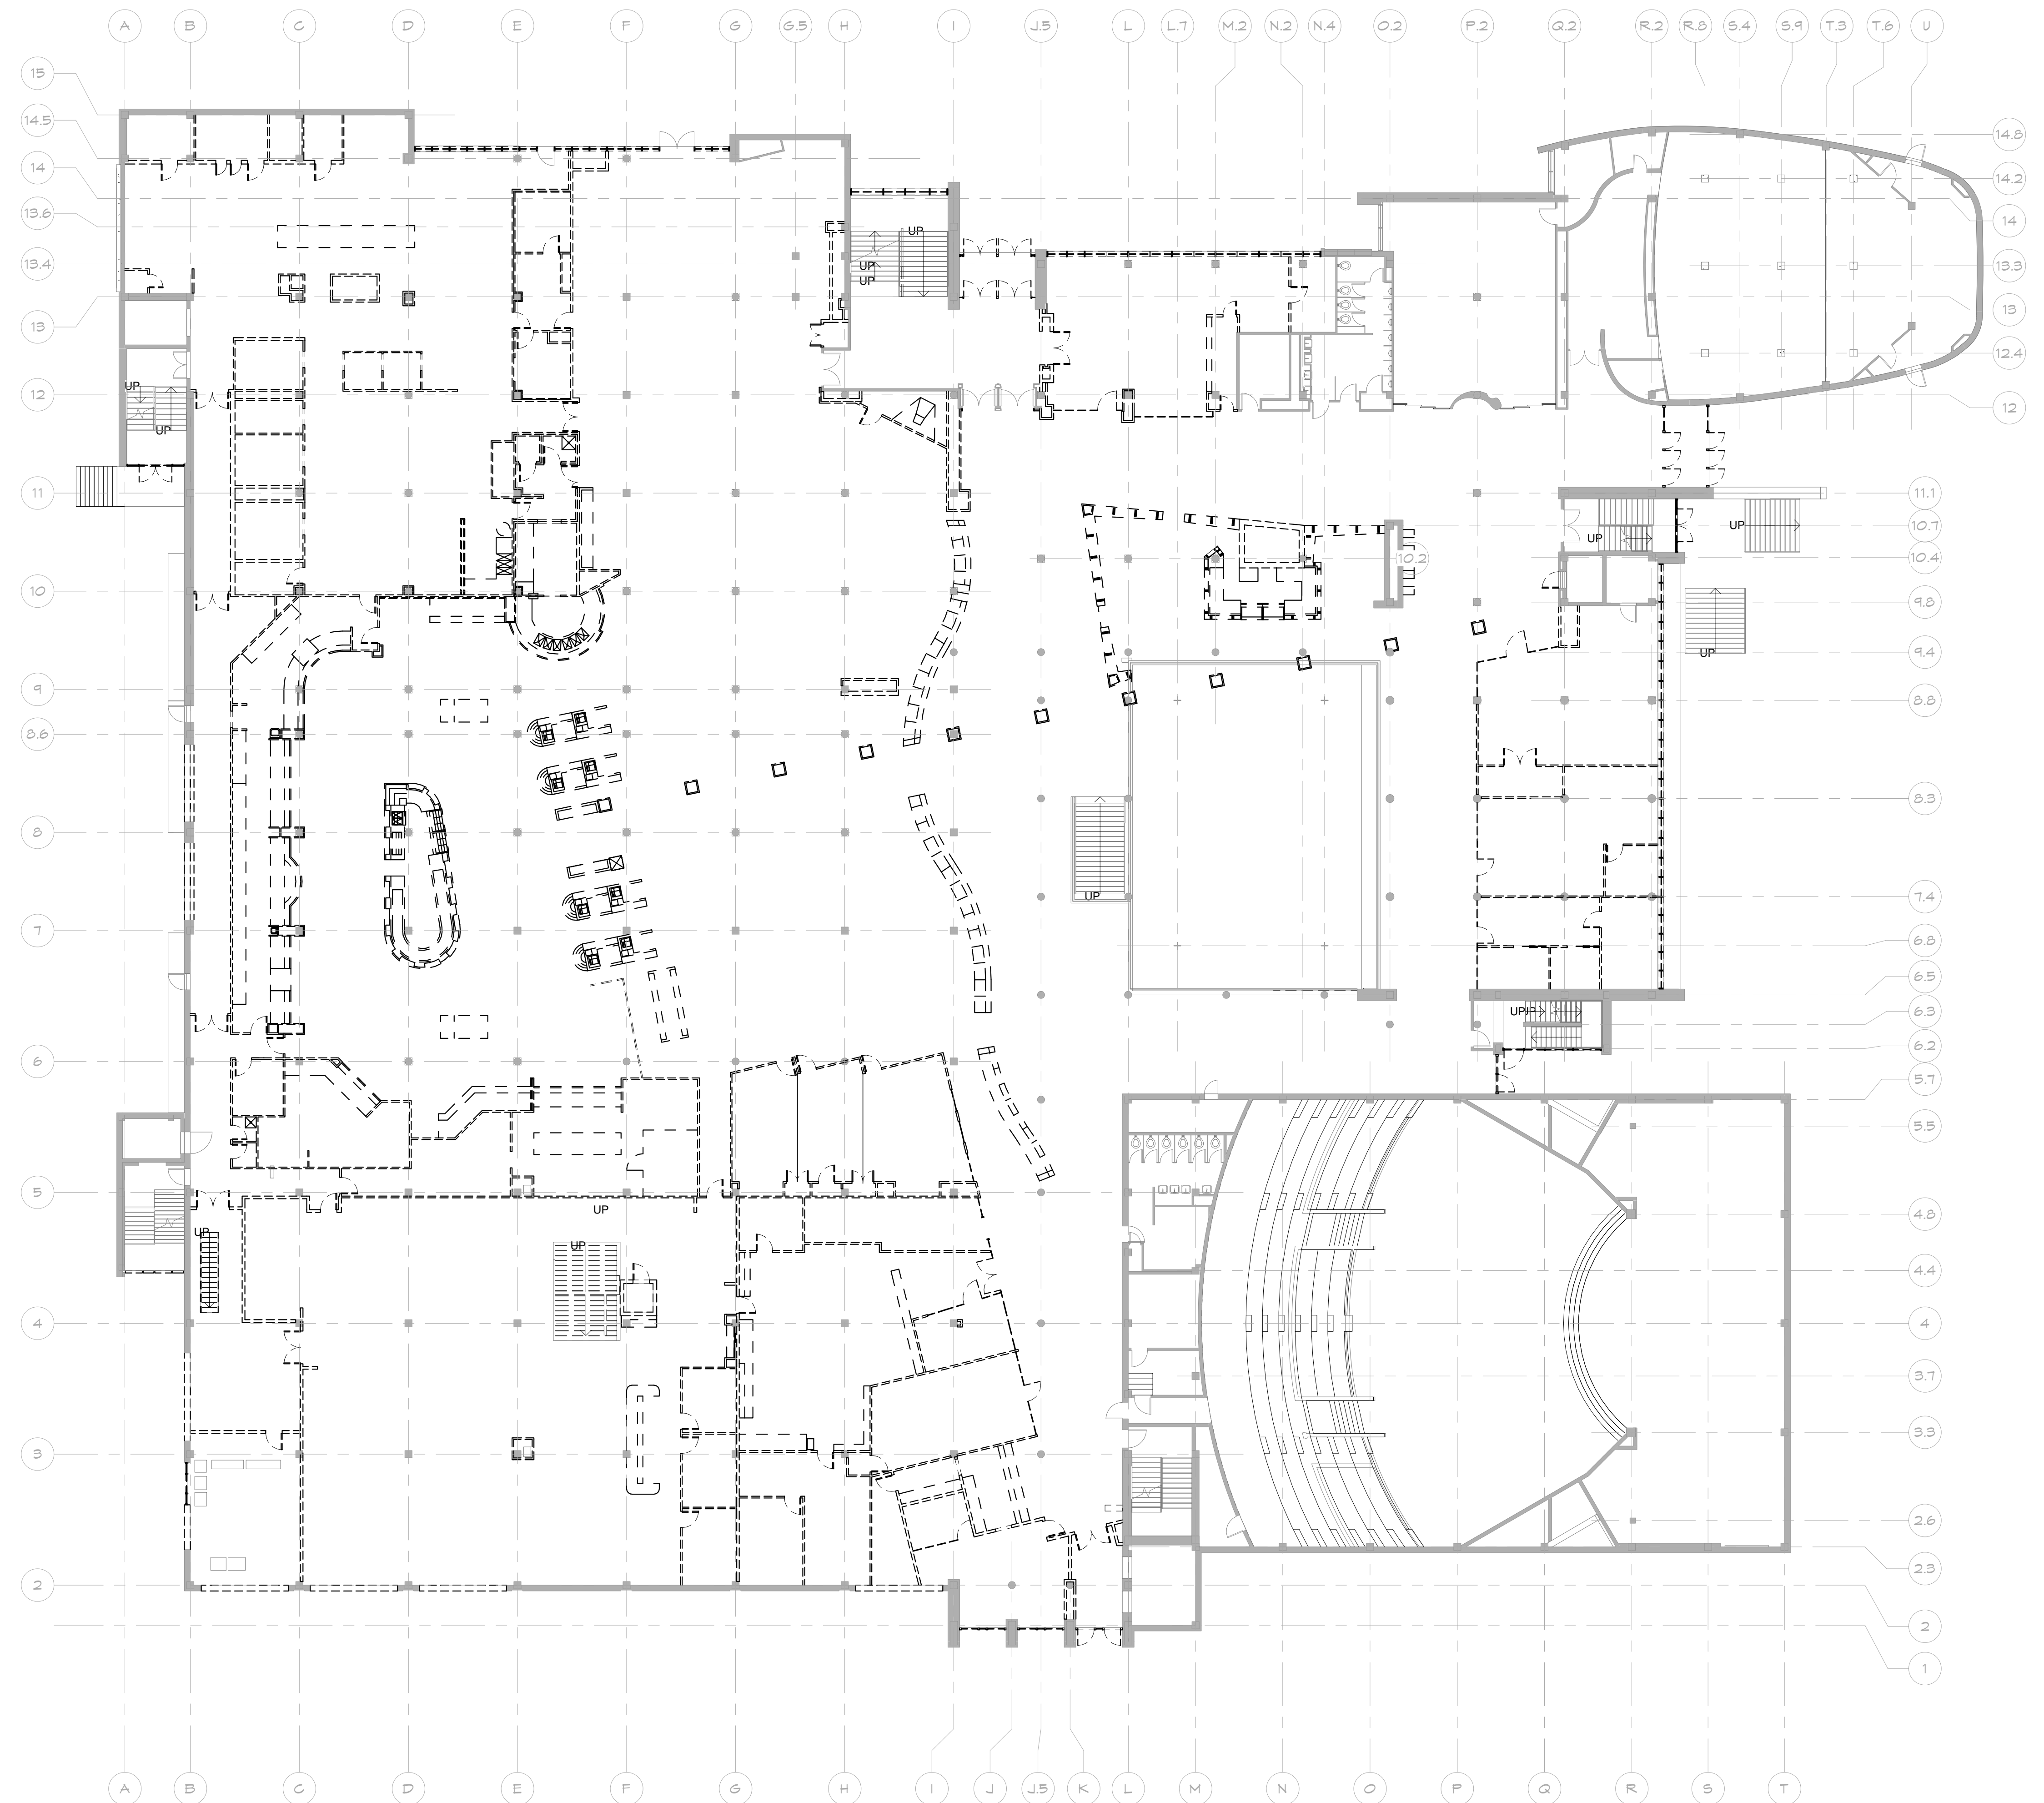

FIRST LEVEL-DEMOLITION
1/16" = 1'-0"

PROGRESS DOCUMENT
NOT FOR CONSTRUCTION

KSU DWG NO.
DR 2014-XXX

SHEET
OF

TOTAL SHEETS IN SET
XXX

Department of Administration
Office of Construction Management
Landon Street Office Building
800 SW Jackson, Suite 700
Topeka, Kansas 66612-1216
Phone 785-296-8899
Fax 785-296-8898



KANSAS STATE UNIVERSITY
STUDENT UNION RENOVATION
KSU STUDENT UNION- MANHATTAN, KS 66502
BUILDING NUMBER 36700-00101
DATE: Issue _____
By: Author _____
Checked By: _____
Date _____

FIRST LEVEL-DEMOLITION PLAN

A-012552

A009

SCHEMATIC DESIGN

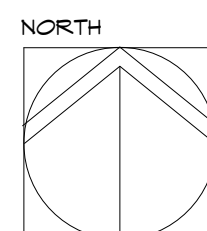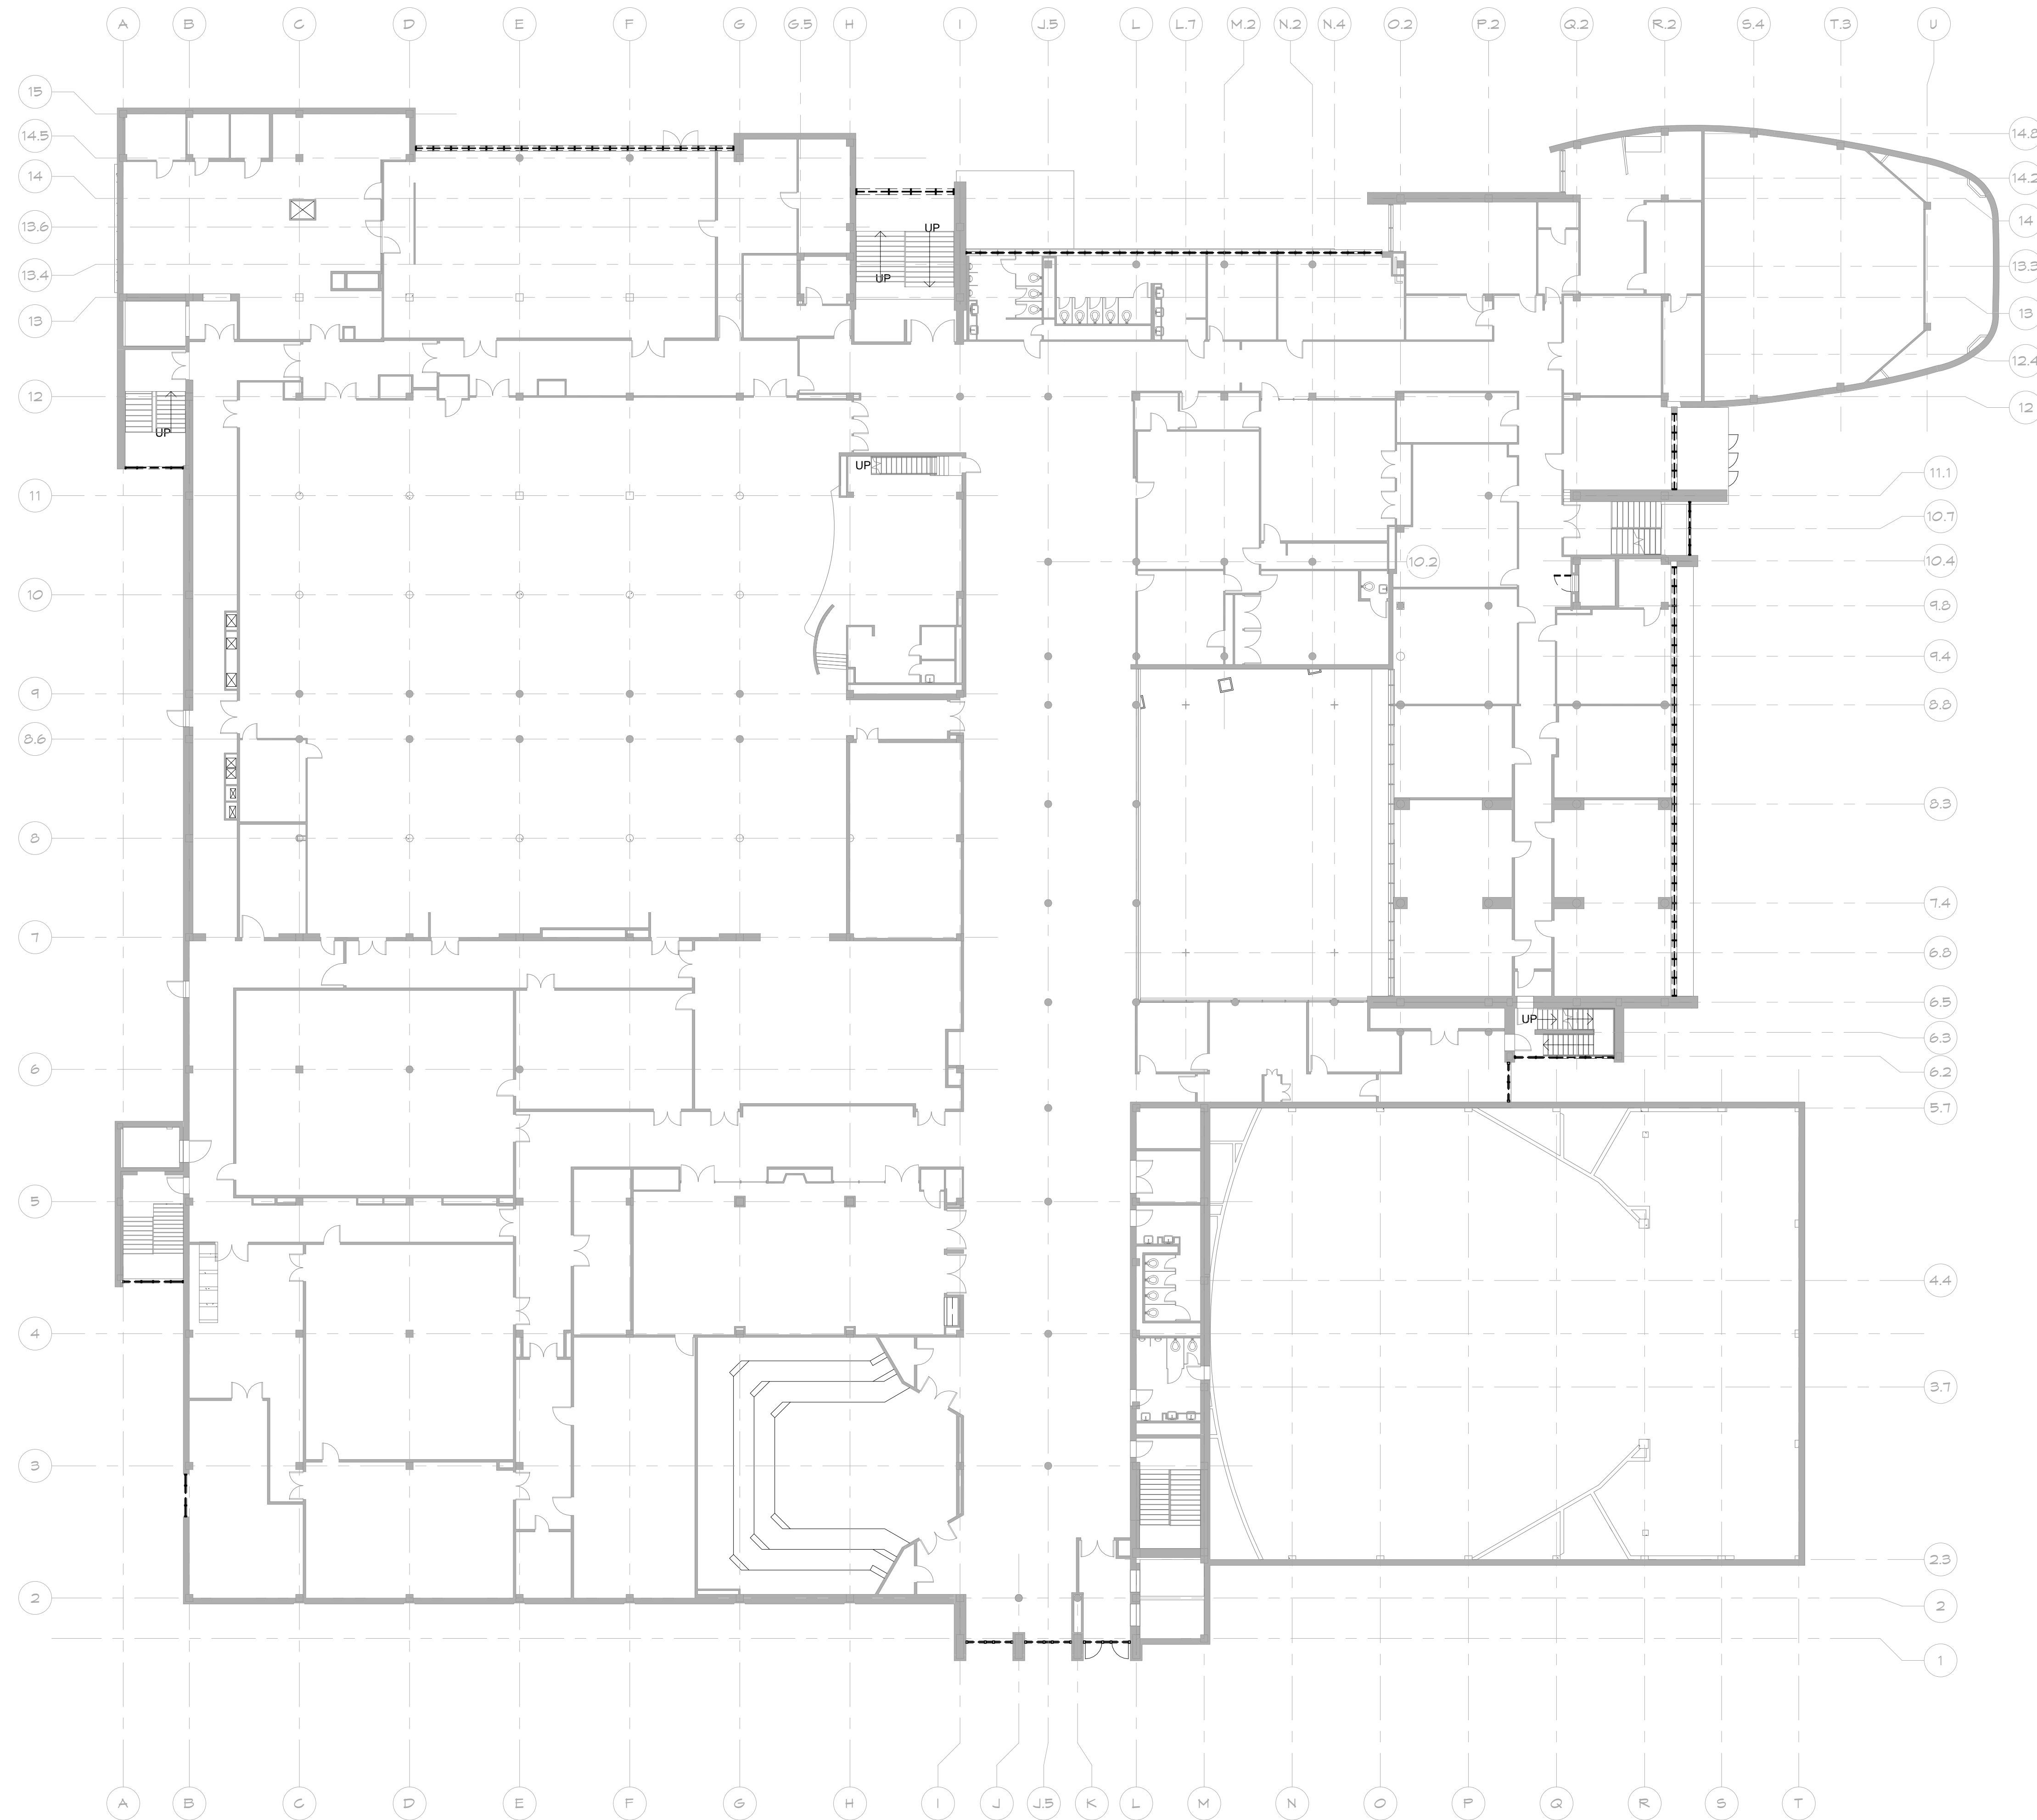

SECOND LEVEL-DEMOLITION
1/16" = 1'-0"

PROGRESS DOCUMENT
NOT FOR CONSTRUCTION

KSU DWG NO.
DR 2014-XXX

SHEET
OF

TOTAL SHEETS IN SET
XXX

Department of Administration
Office of Construction Management
Landon Street Office Building
800 SW Jackson, Suite 700
Topeka, Kansas 66612-1216
Phone 785-296-8899
Fax 785-296-8898



KANSAS STATE UNIVERSITY
STUDENT UNION RENOVATION
KSU STUDENT UNION- MANHATTAN, KS 66502
BUILDING NUMBER 36700-00101
DATE: Issue
By/Author: Checked BY: Check/REV: No
Date

SECOND LEVEL-DEMOLITION PLAN

A-012552

A010

SCHEMATIC DESIGN

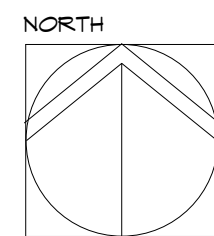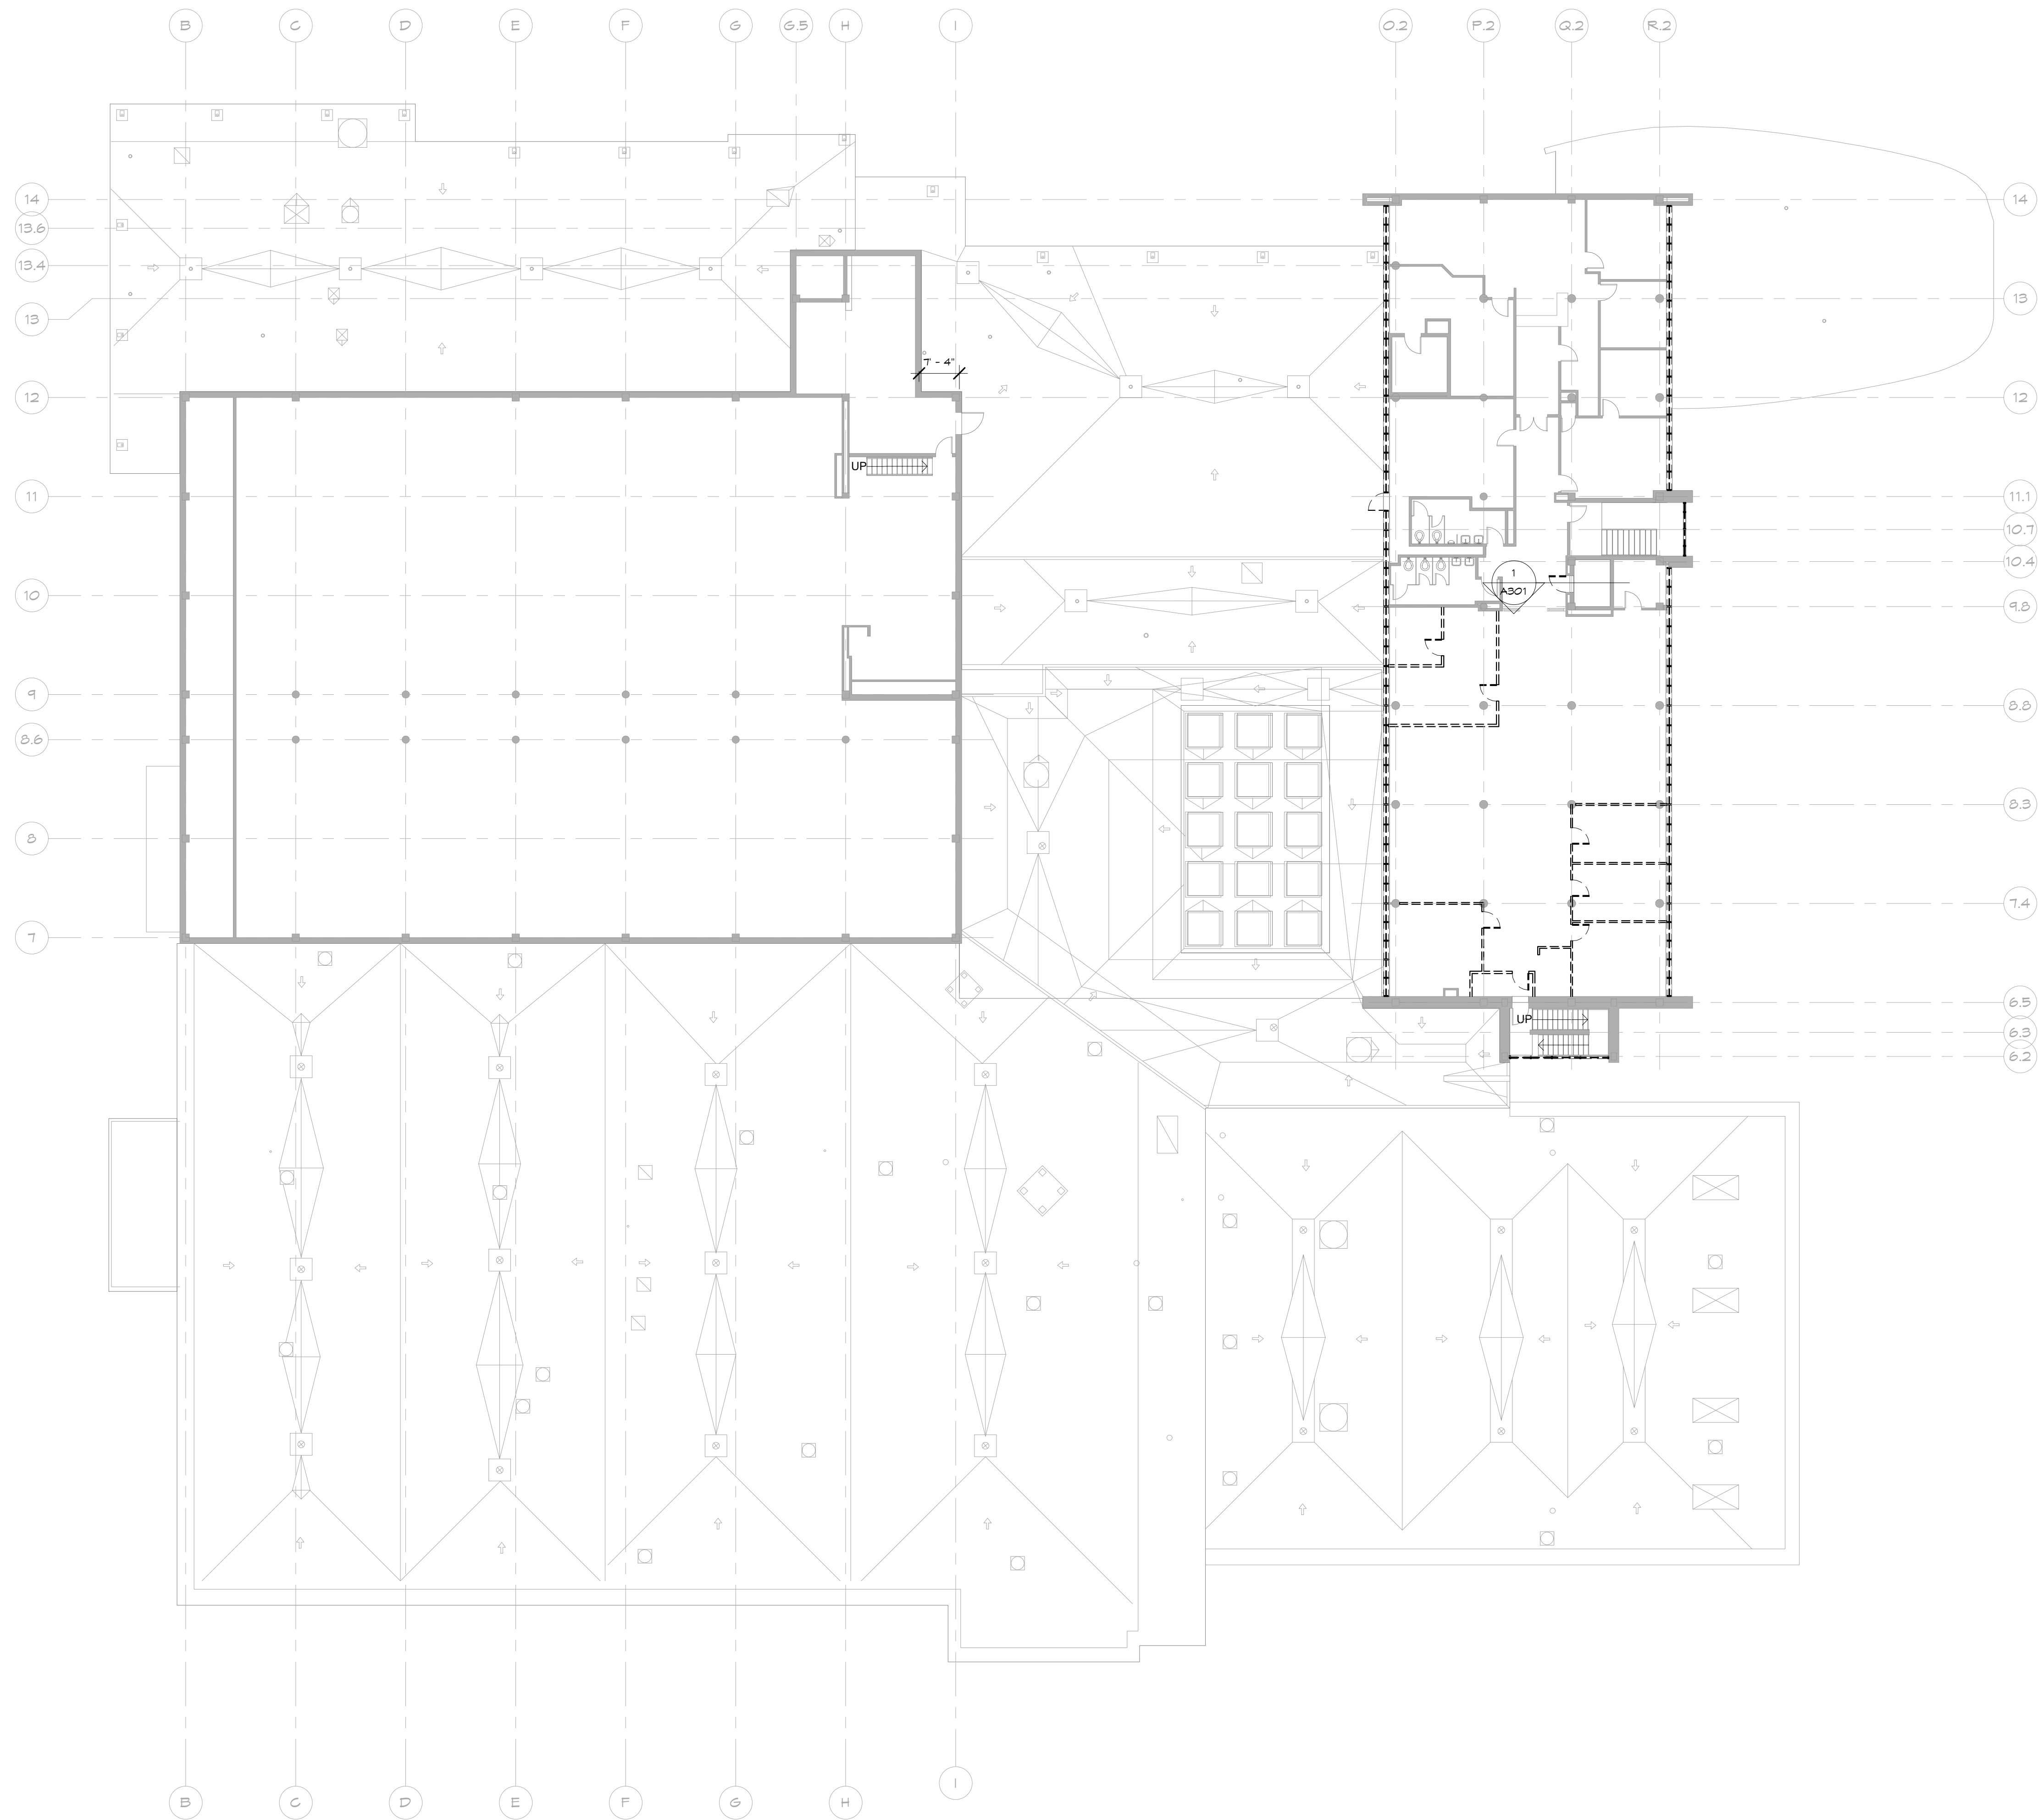

THIRD LEVEL-DEMOLITION
1/16" = 1'-0"

PROGRESS DOCUMENT
NOT FOR CONSTRUCTION

KSU DWG NO.
DR 2014-XXX

SHEET
OF

TOTAL SHEETS IN SET
XXX

Department of Administration
Office of Construction Management
Landon Street Office Building
800 SW Jackson, Suite 700
Topeka, Kansas 66612-1216
Phone 785-296-8899
Fax 785-296-8898

KANSAS STATE UNIVERSITY
STUDENT UNION RENOVATION
KSU STUDENT UNION- MANHATTAN, KS 66502
BUILDING NUMBER 36700-00101

PROGRESS DOCUMENT
NOT FOR CONSTRUCTION



THIRD LEVEL-
DEMOLITION PLAN

A-012552

A011

SCHEMATIC DESIGN

DATE: Issue
Date
BY: Author
CHECKED BY: Checker
REV: No

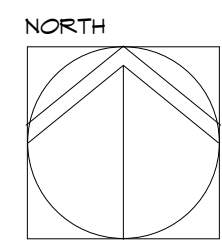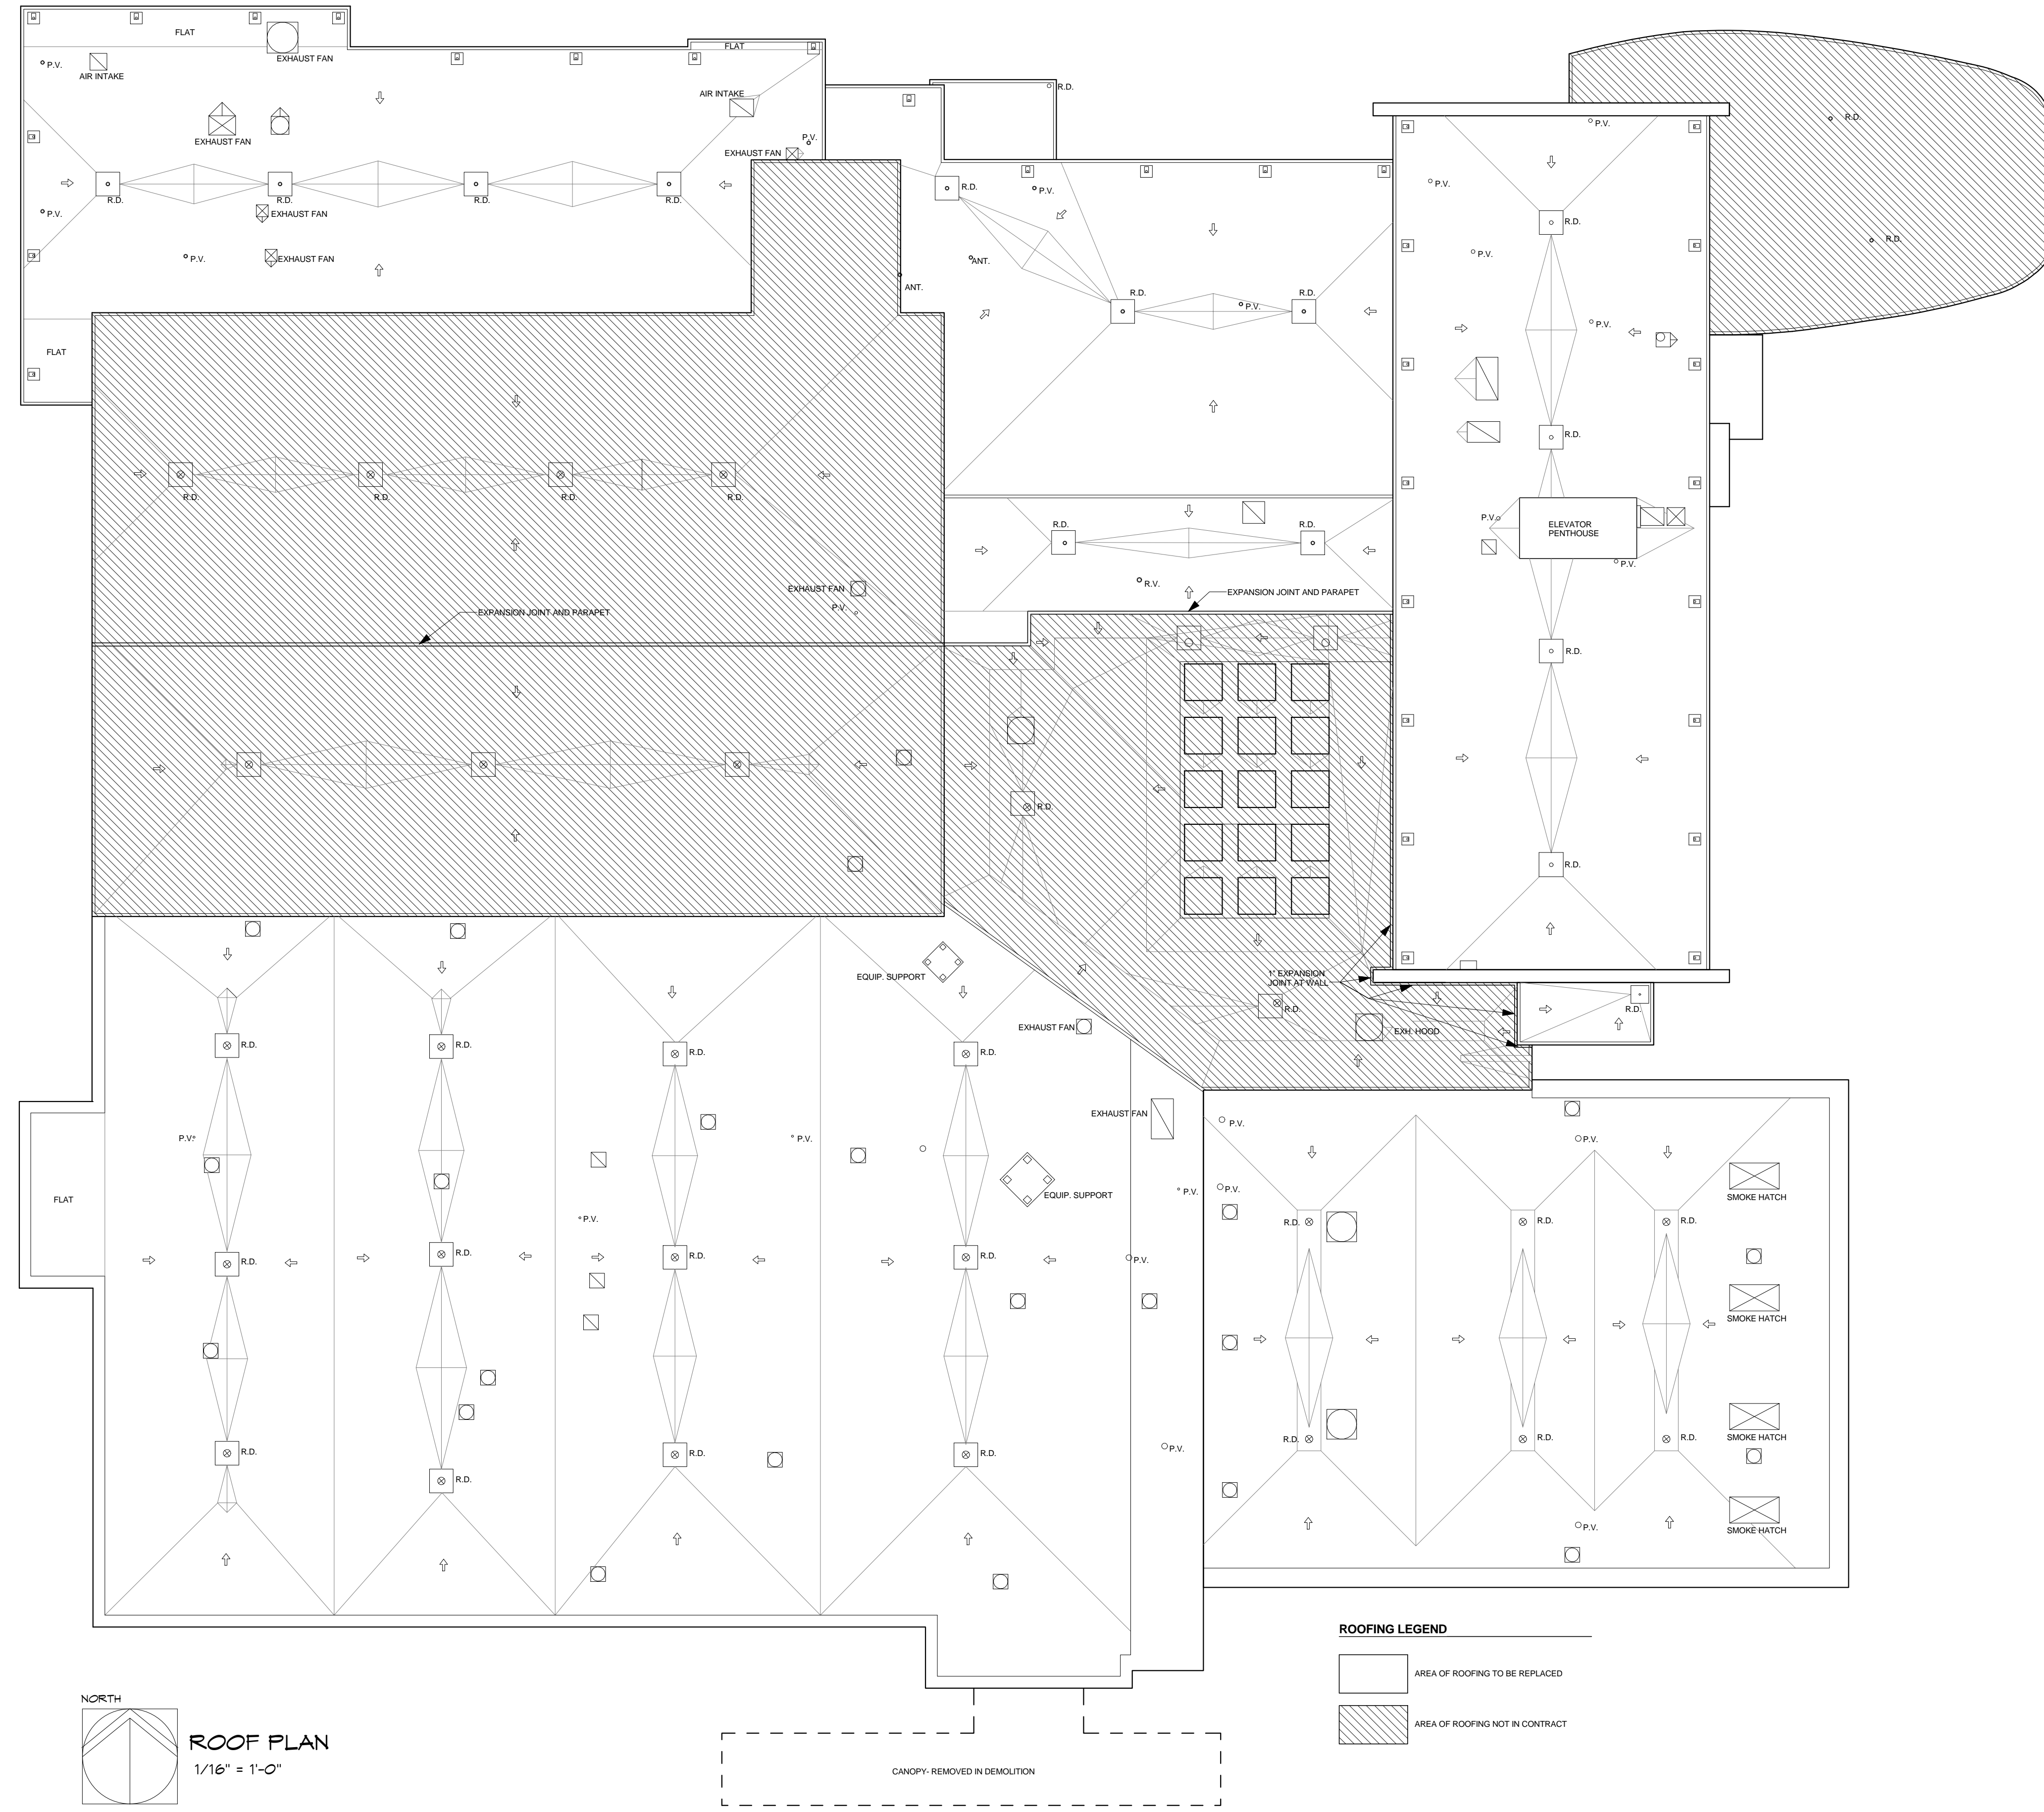

ROOF PLAN
1/16" = 1'-0"

ROOFING LEGEND

□ AREA OF ROOFING TO BE REPLACED

▨ AREA OF ROOFING NOT IN CONTRACT

PROGRESS DOCUMENT
NOT FOR CONSTRUCTION

KSU DWG NO.
DR 2014-XXX

SHEET
OF

TOTAL SHEETS IN SET
XXX

Department of Administration
Office of Construction Management
Landon Street Office Building
800 SW Jackson, Suite 700
Topeka, Kansas 66612-1216
Phone 785-296-8899
Fax 785-296-8888


KANSAS STATE UNIVERSITY
STUDENT UNION RENOVATION
KSU STUDENT UNION - MANHATTAN, KS 66502
BUILDING NUMBER 36700-00101
DATE: Issue
BY: Author
CHECKED BY: Checker
REV: No

ROOFING PLAN


A-012552

A118


SCHEMATIC DESIGN

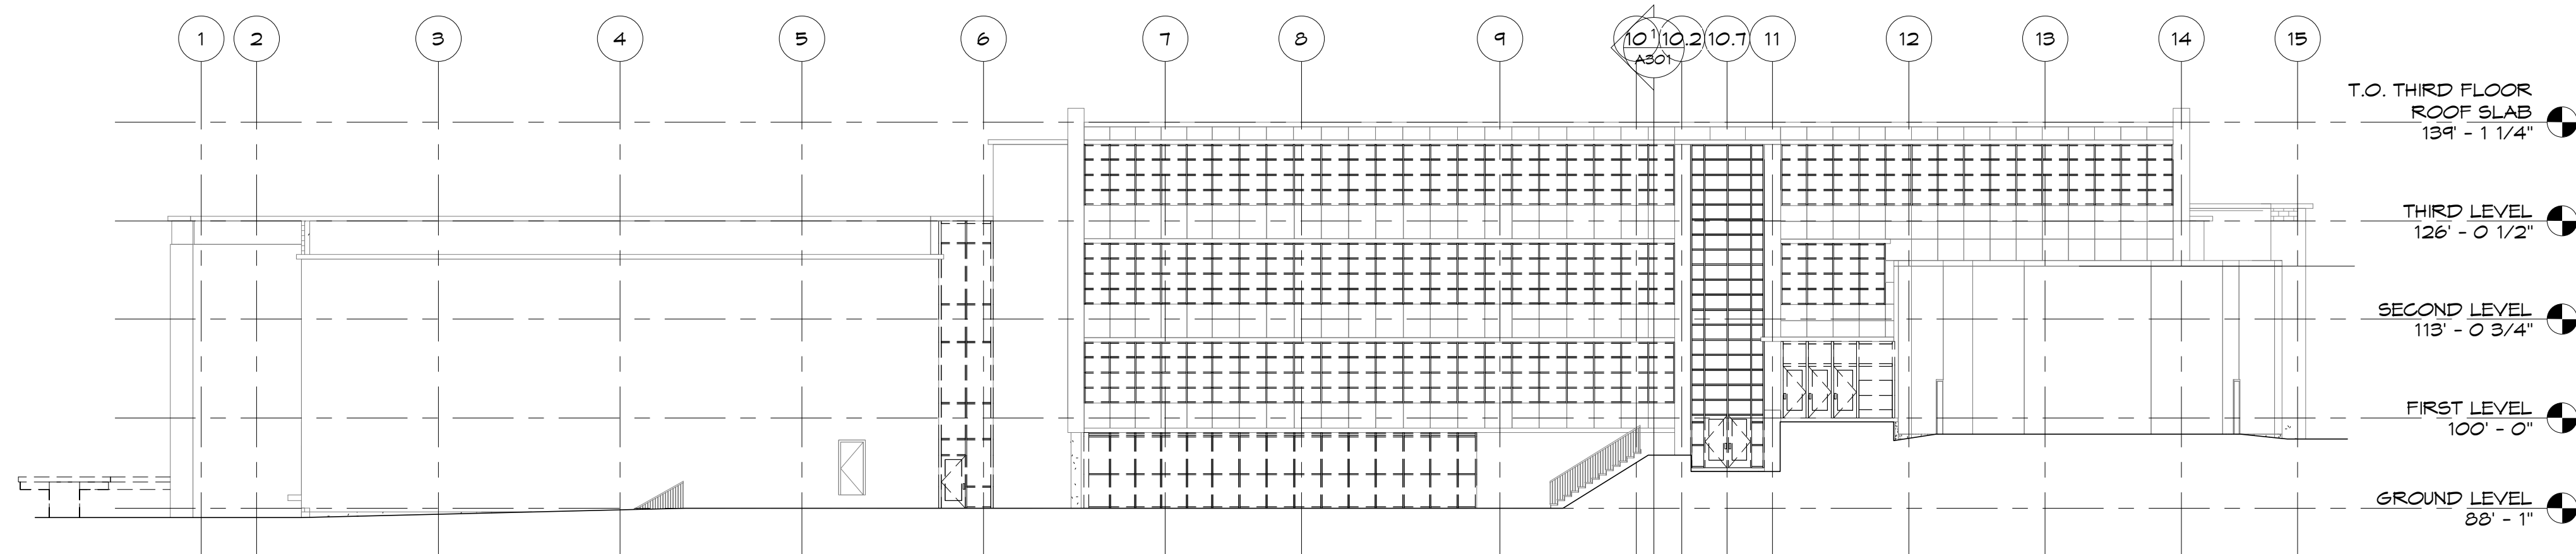

3 EAST ELEVATION-DEMOLITION
1/16" = 1'-0"

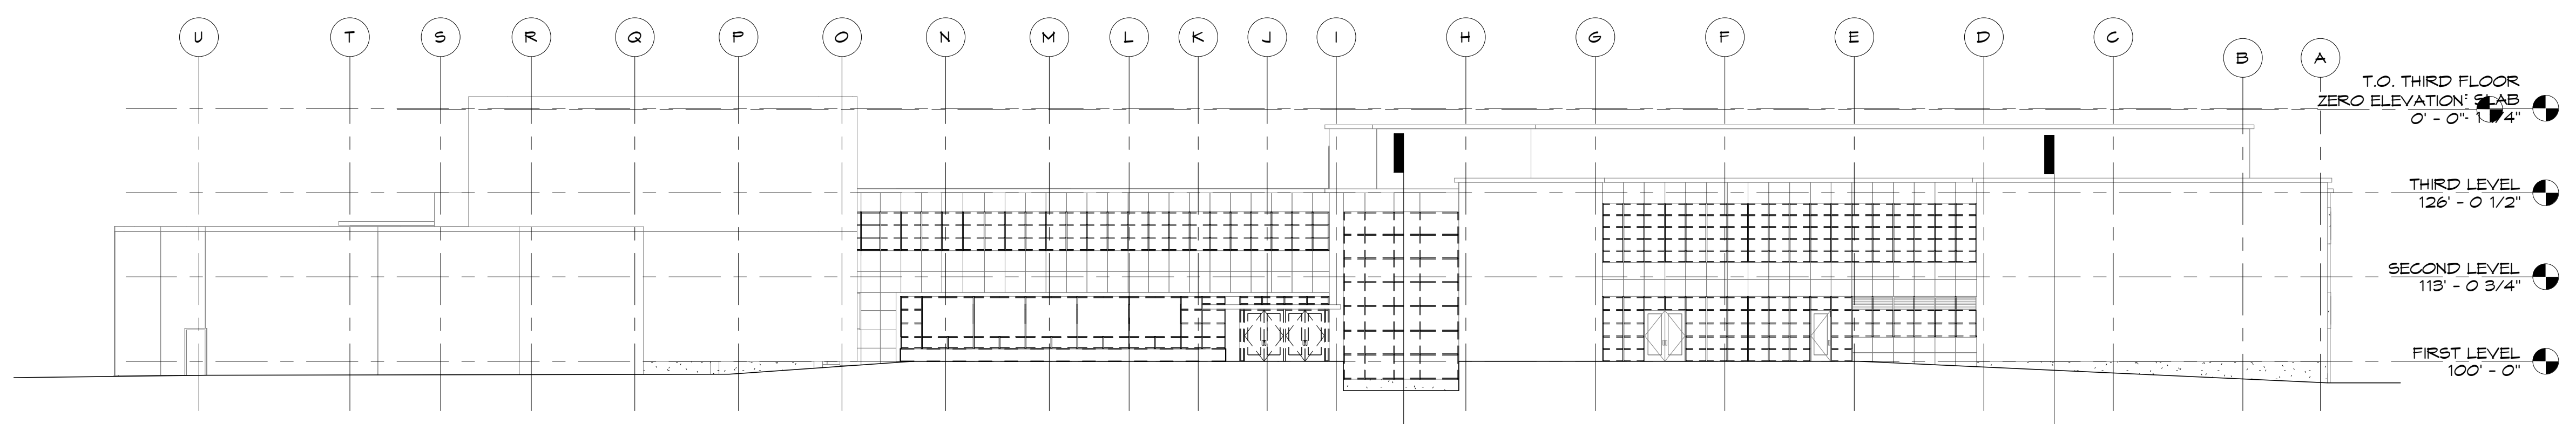

1 NORTH ELEVATION-DEMOLITION
1/16" = 1'-0"

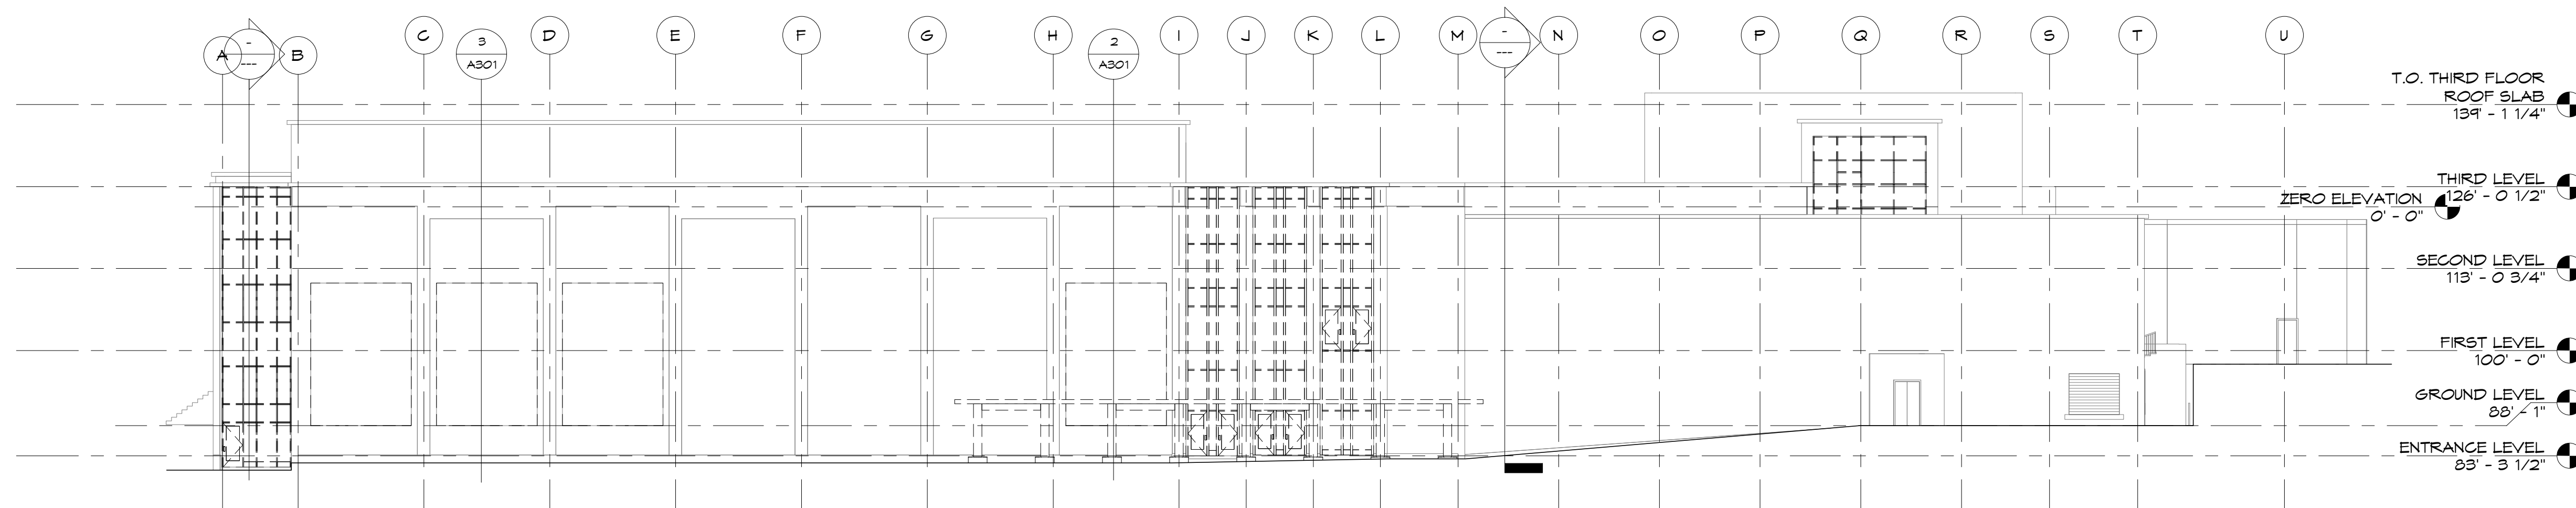

2 SOUTH ELEVATION-DEMOLITION
1/16" = 1'-0"

PROGRESS DOCUMENT
NOT FOR CONSTRUCTION

KSU DWG NO.
DR 2014-XXX

SHEET
OF

TOTAL SHEETS IN SET
XXX

Department of Administration
Office of Construction Management
Landon Street Office Building
800 SW Jackson, Suite 700
Topeka, Kansas 66612-1216
Phone 785-236-8899
Fax 785-296-8888


KANSAS STATE UNIVERSITY
STUDENT UNION RENOVATION
KSU STUDENT UNION- MANHATTAN, KS 66502
BUILDING NUMBER 36700-00101
DATE: Issue
BY: Author
CHECKED BY: Checkerev: No
Date

EXTERIOR
ELEVATIONS-
DEMOLITION


A-012552

A201


SCHEMATIC DESIGN

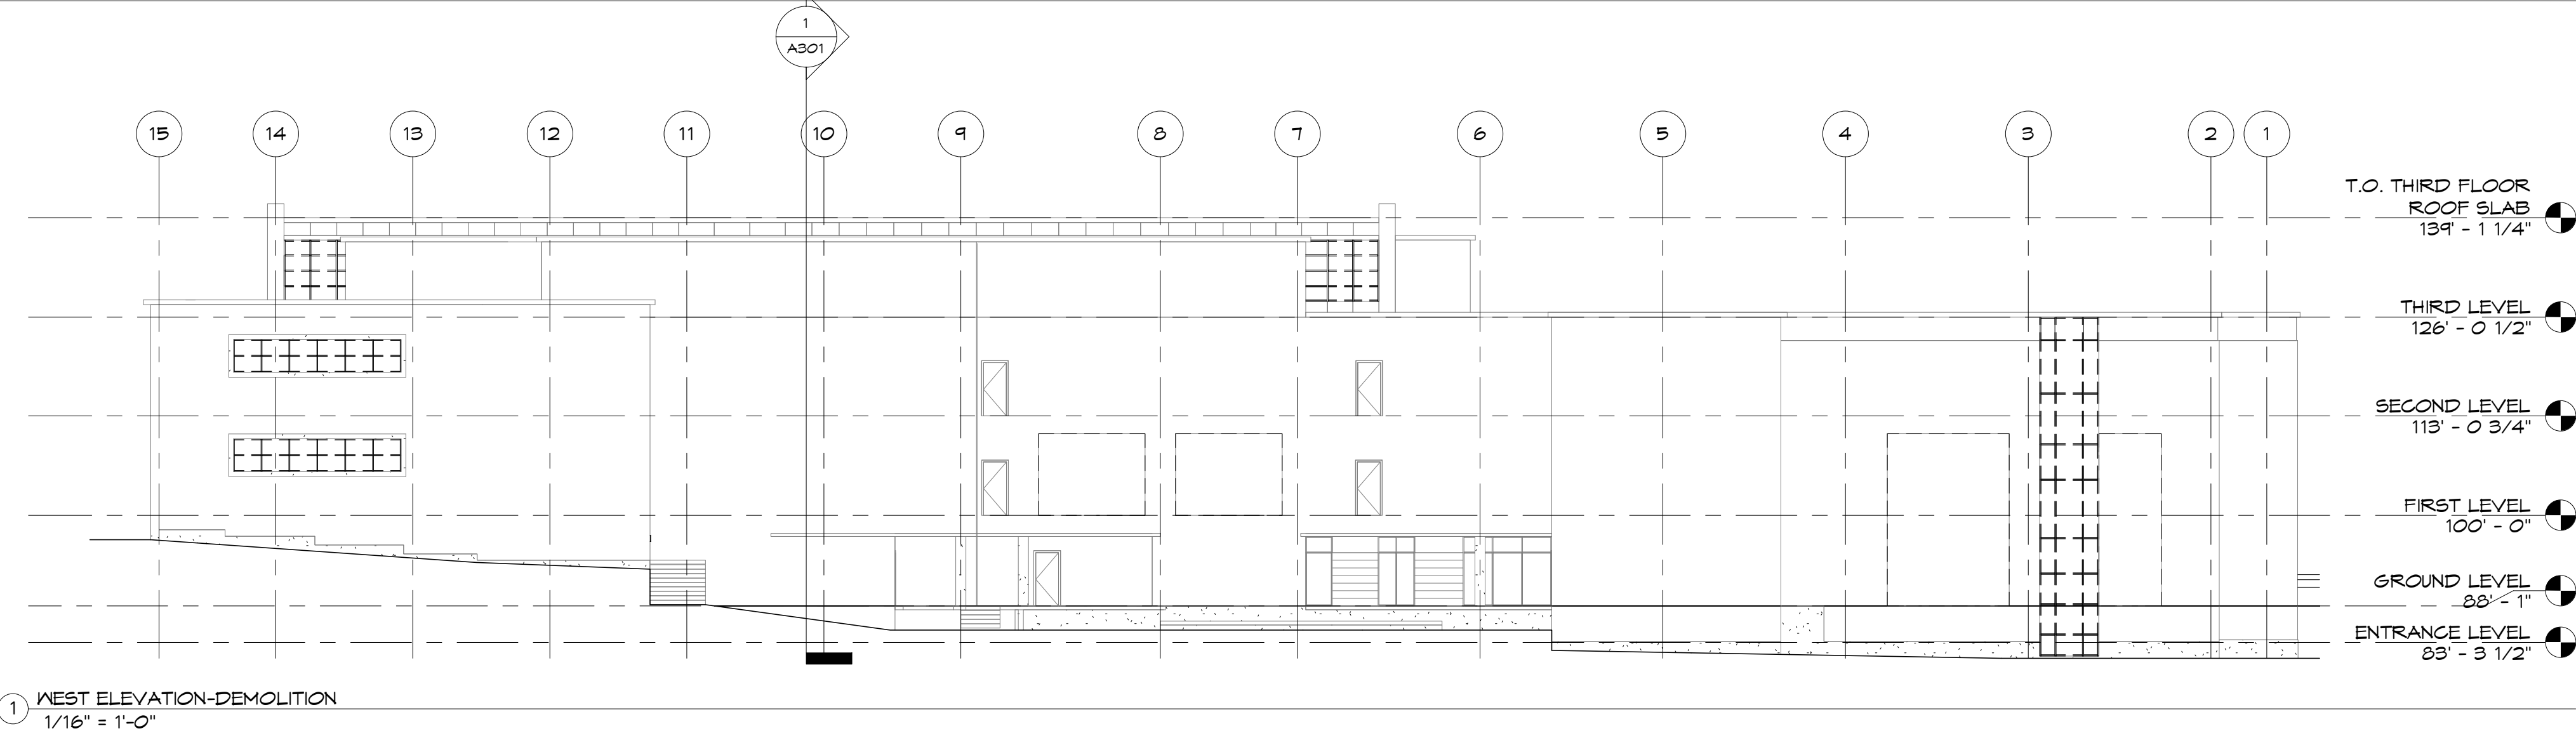


1 WEST ELEVATION-DEMOLITION
1/16" = 1'-0"

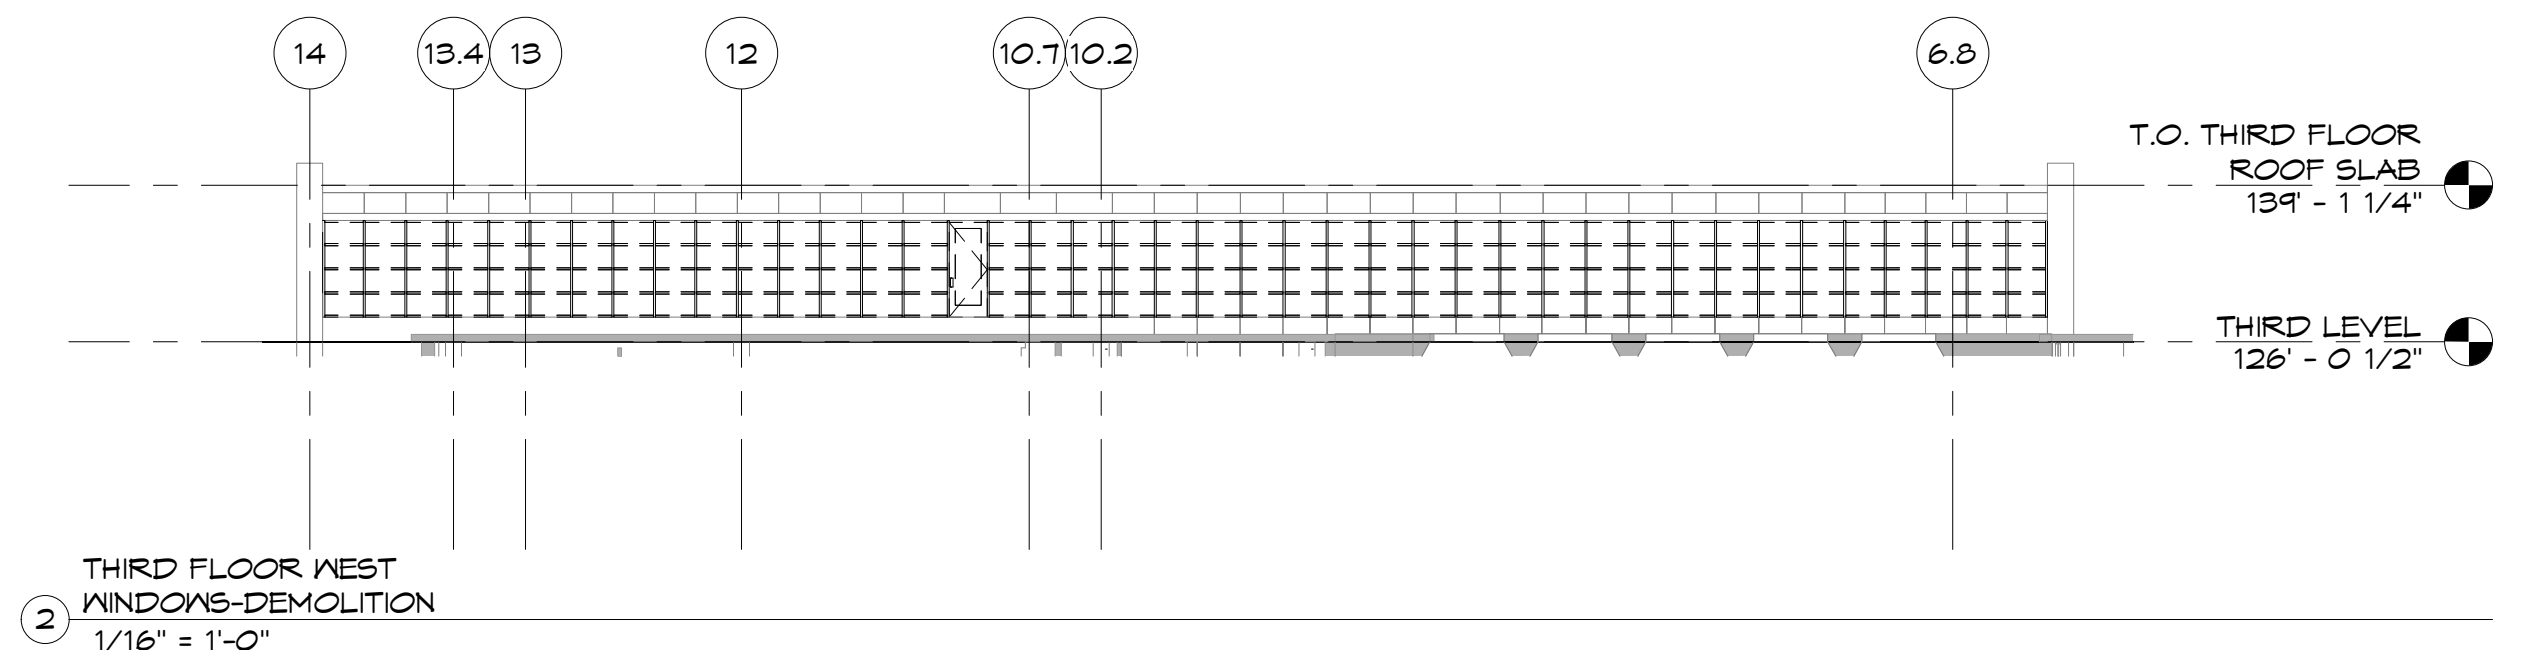


2 THIRD FLOOR WEST WINDOWS-DEMOLITION
1/16" = 1'-0"

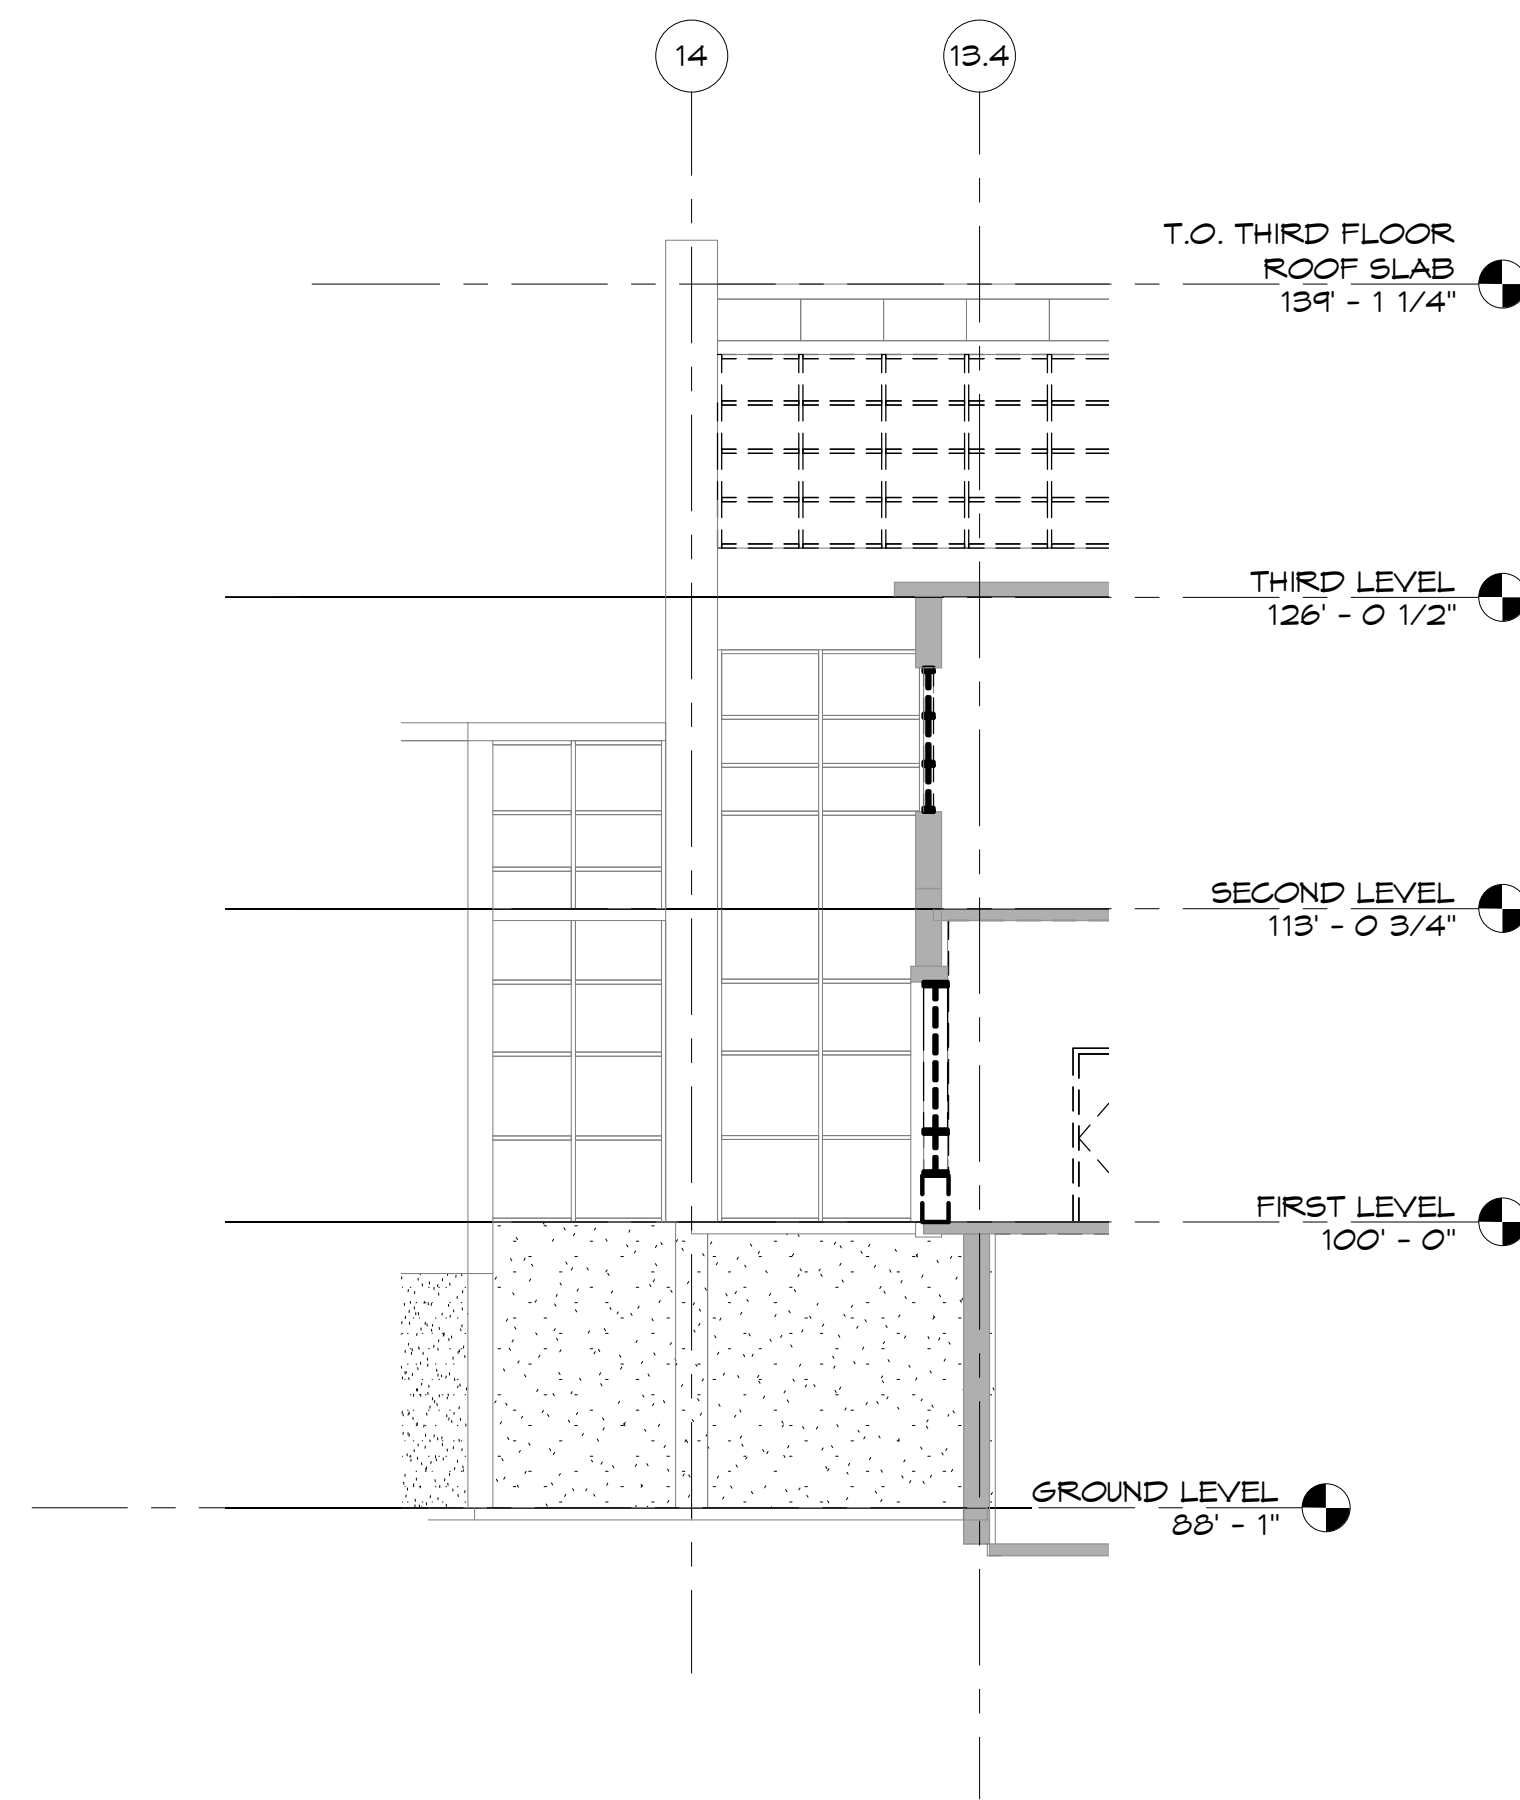


3 NORTH SIDE WEST WEST ELEVATIONS-DEMOLITION
1/8" = 1'-0"

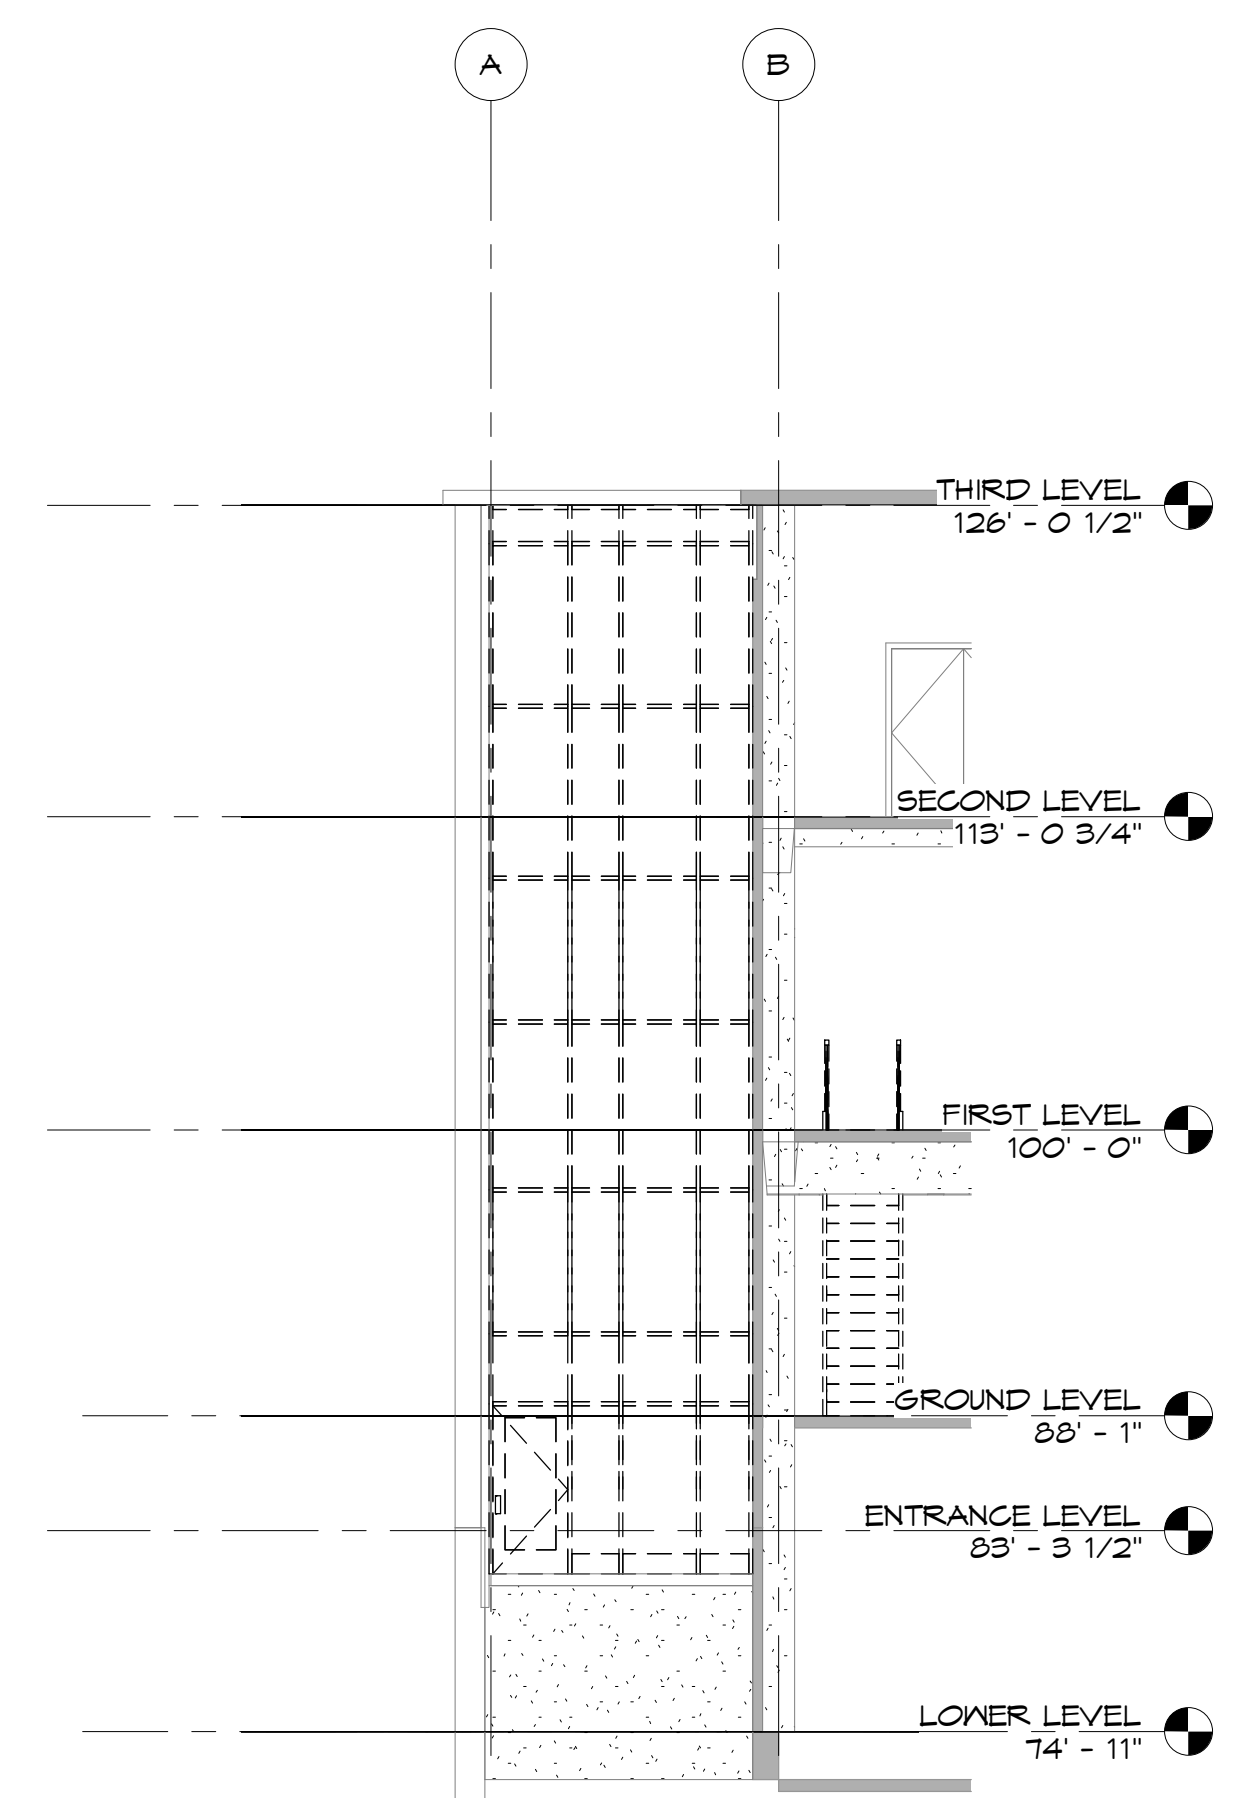

4 WEST SIDE SOUTH STAIR ELEVATION-DEMOLITION
1/8" = 1'-0"

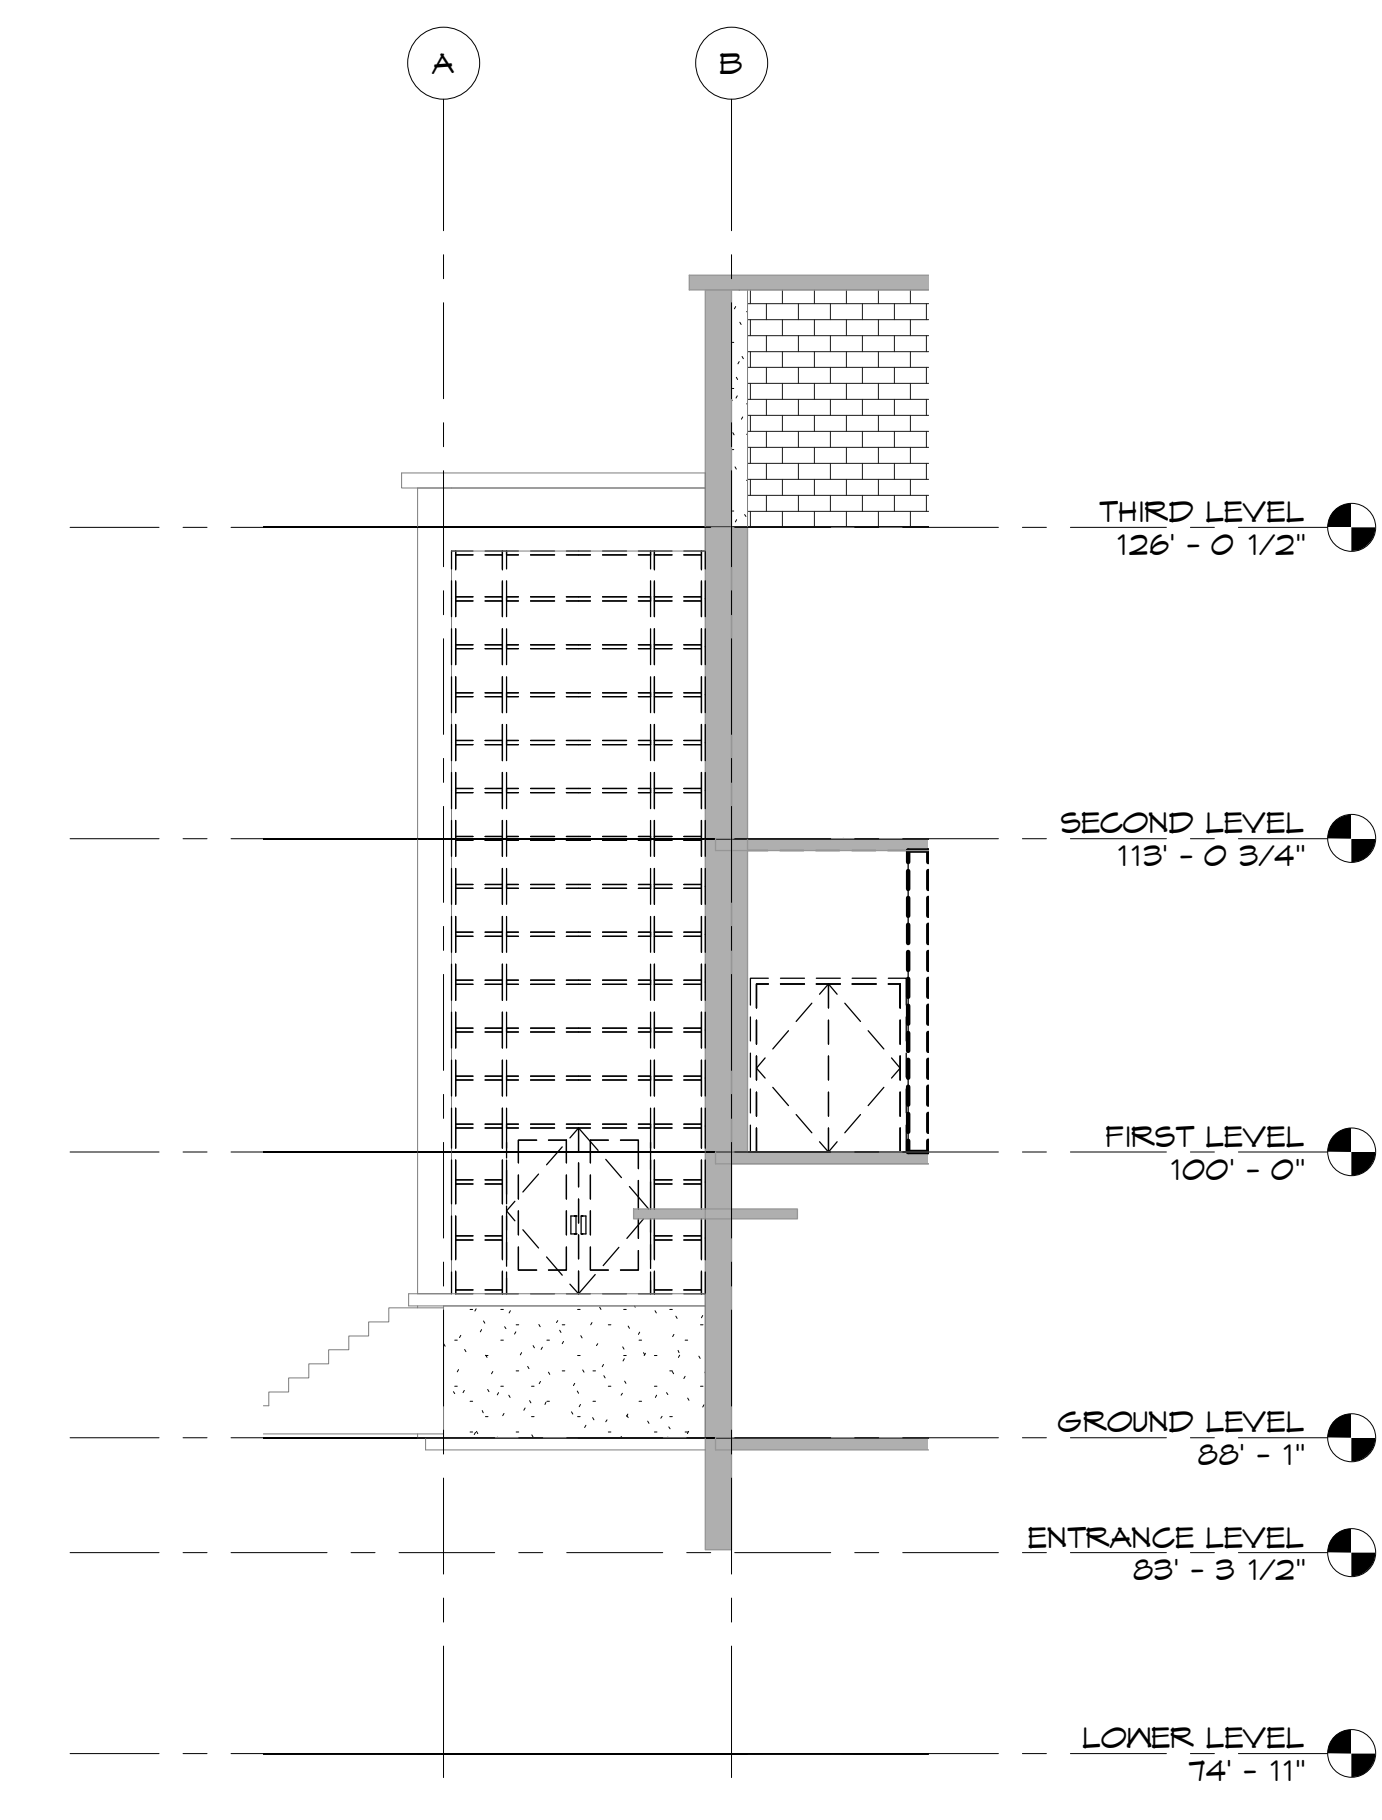

5 WEST SIDE NORTH STAIR ELEVATION-DEMOLITION
1/8" = 1'-0"

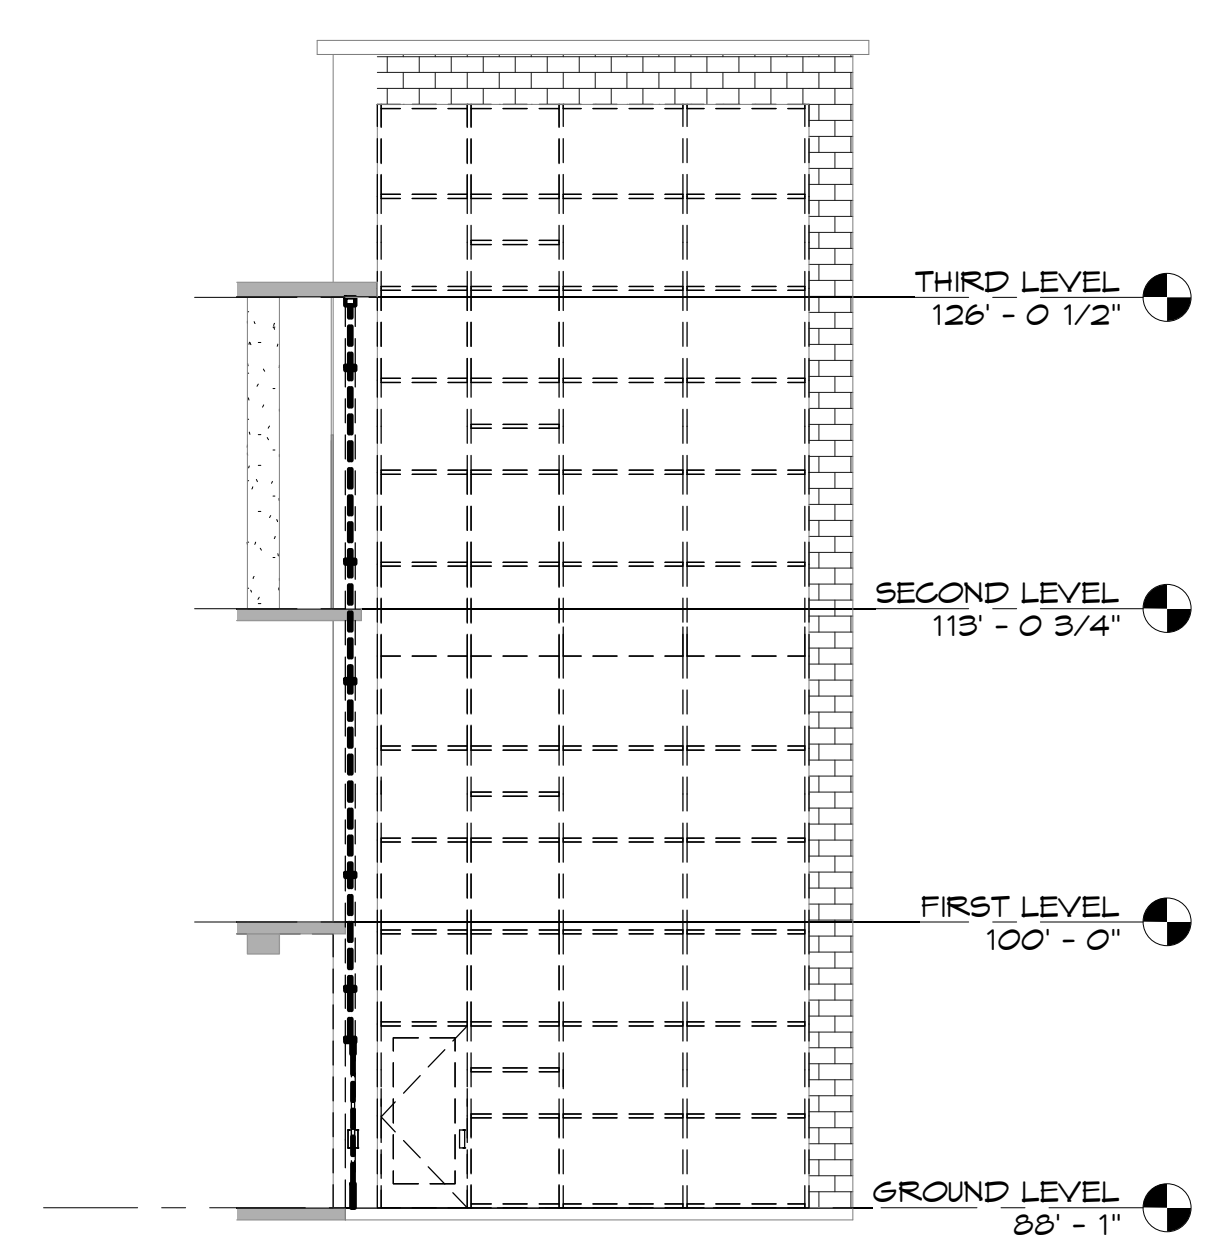

6 EAST SIDE SOUTH STAIR ELEVATION-DEMOLITION
1/8" = 1'-0"

PROGRESS DOCUMENT
NOT FOR CONSTRUCTION

KSU DWG NO.
DR 2014-XXX

SHEET
OF

TOTAL SHEETS IN SET
XXX

Department of Administration
Office of Construction Management
Office of Student Union Renovation
Landon Street Office Building
800 SW Jackson, Suite 700
Topeka, Kansas 66612-1216
Phone: 785-296-8899
Fax: 785-296-8898


KANSAS STATE UNIVERSITY
STUDENT UNION RENOVATION
KSU STUDENT UNION- MANHATTAN, KS 66502
BUILDING NUMBER 36700-00101
DATE: Issue
BY: Author
CHECKED BY: Checker
REV: No

EXTERIOR ELEVATIONS-DEMOLITION


A-012552

A202


SCHEMATIC DESIGN

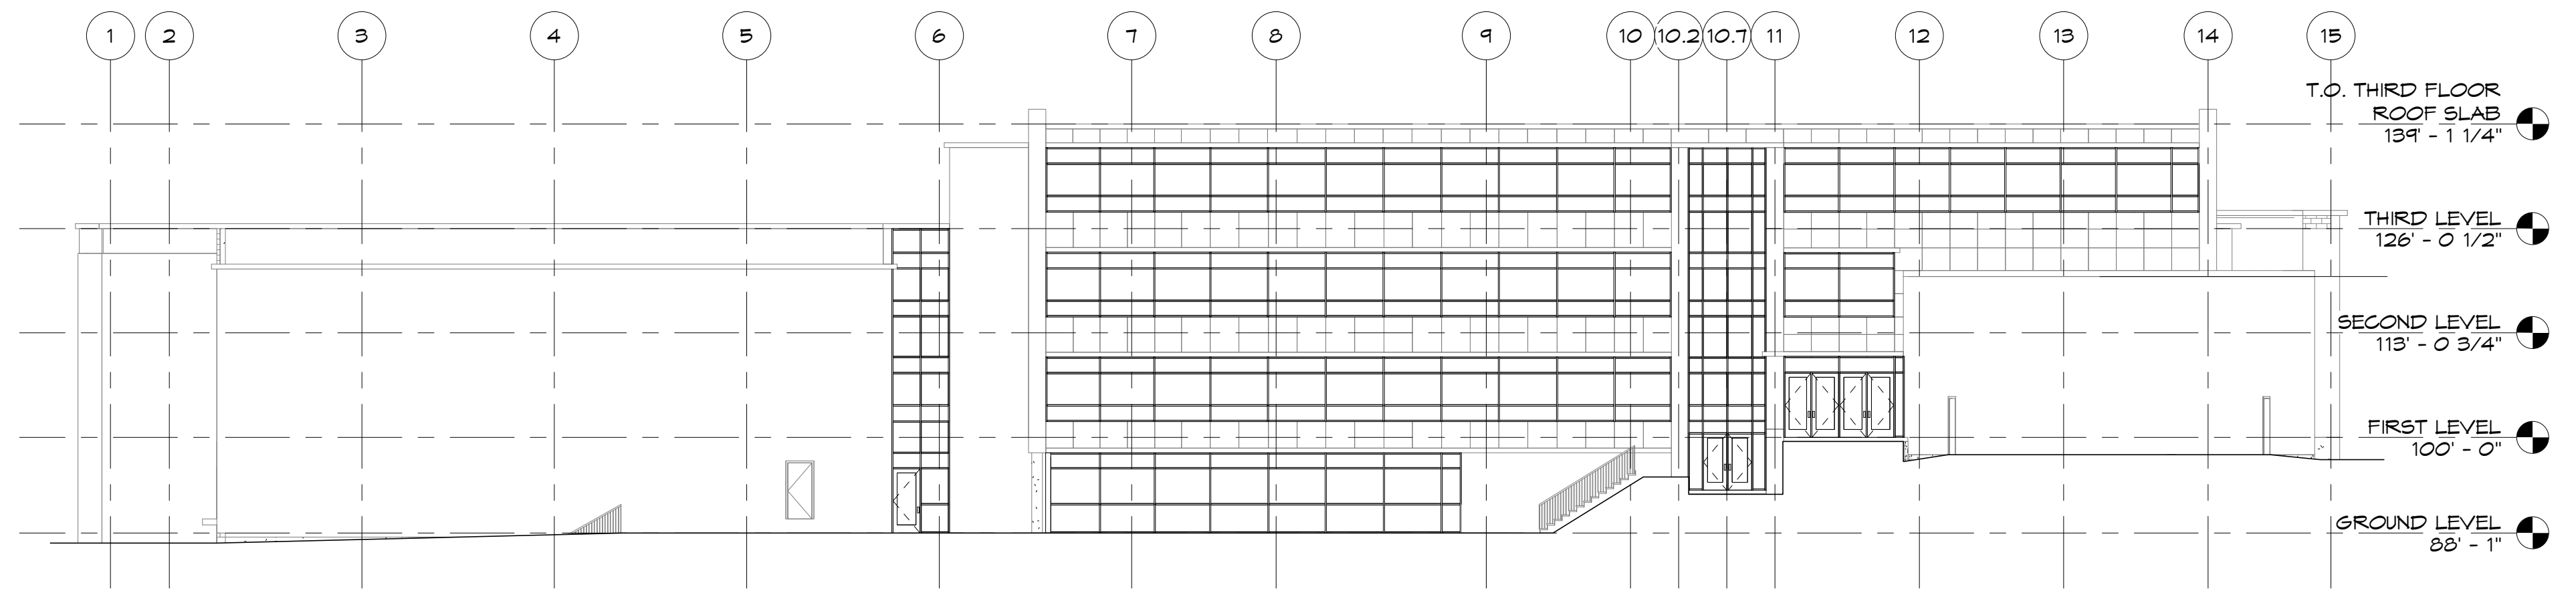

1 EAST ELEVATION
1/16" = 1'-0"

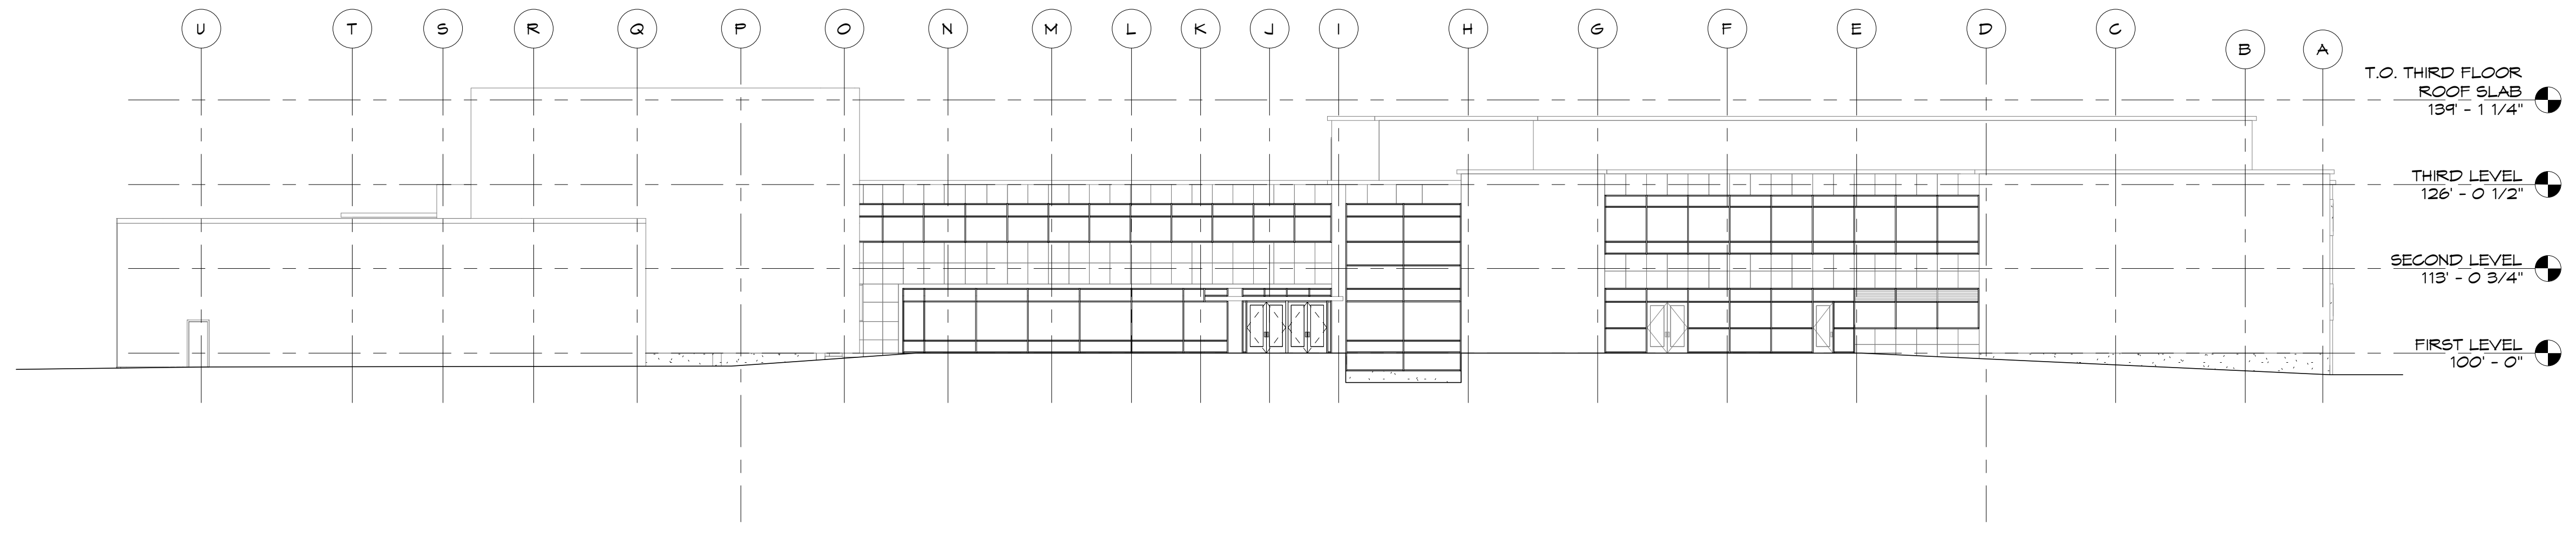

2 NORTH ELEVATION
1/16" = 1'-0"

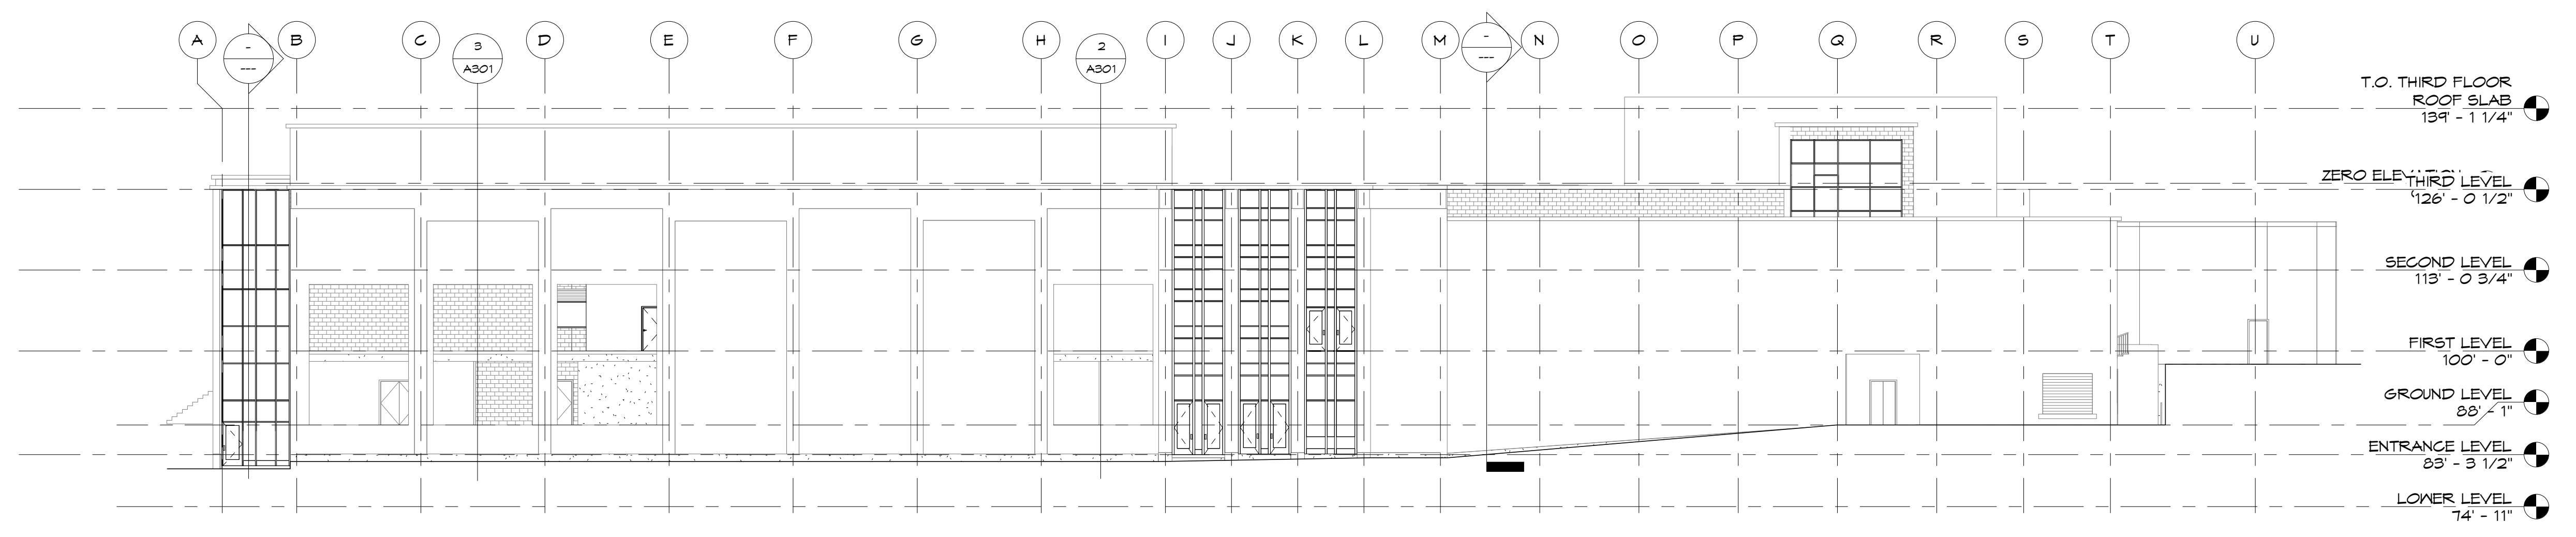

3 SOUTH ELEVATION
1/16" = 1'-0"

PROGRESS DOCUMENT
NOT FOR CONSTRUCTION

KSU DWG NO.
DR 2014-XXX

SHEET
OF

TOTAL SHEETS IN SET
XXX

Department of Administration
Office of Construction Management
Landon Street Office Building
800 SW Jackson, Suite 700
Topeka, Kansas 66612-1216
Phone 785-296-8899
Fax 785-296-8898


KANSAS STATE UNIVERSITY
STUDENT UNION RENOVATION
KSU STUDENT UNION - MANHATTAN, KS 66502
BUILDING NUMBER 36700-00101
DATE: Issue Date
BY: Author CHECKED BY: Checker REV: No

EXTERIOR ELEVATIONS


A-012552

A203


SCHEMATIC DESIGN

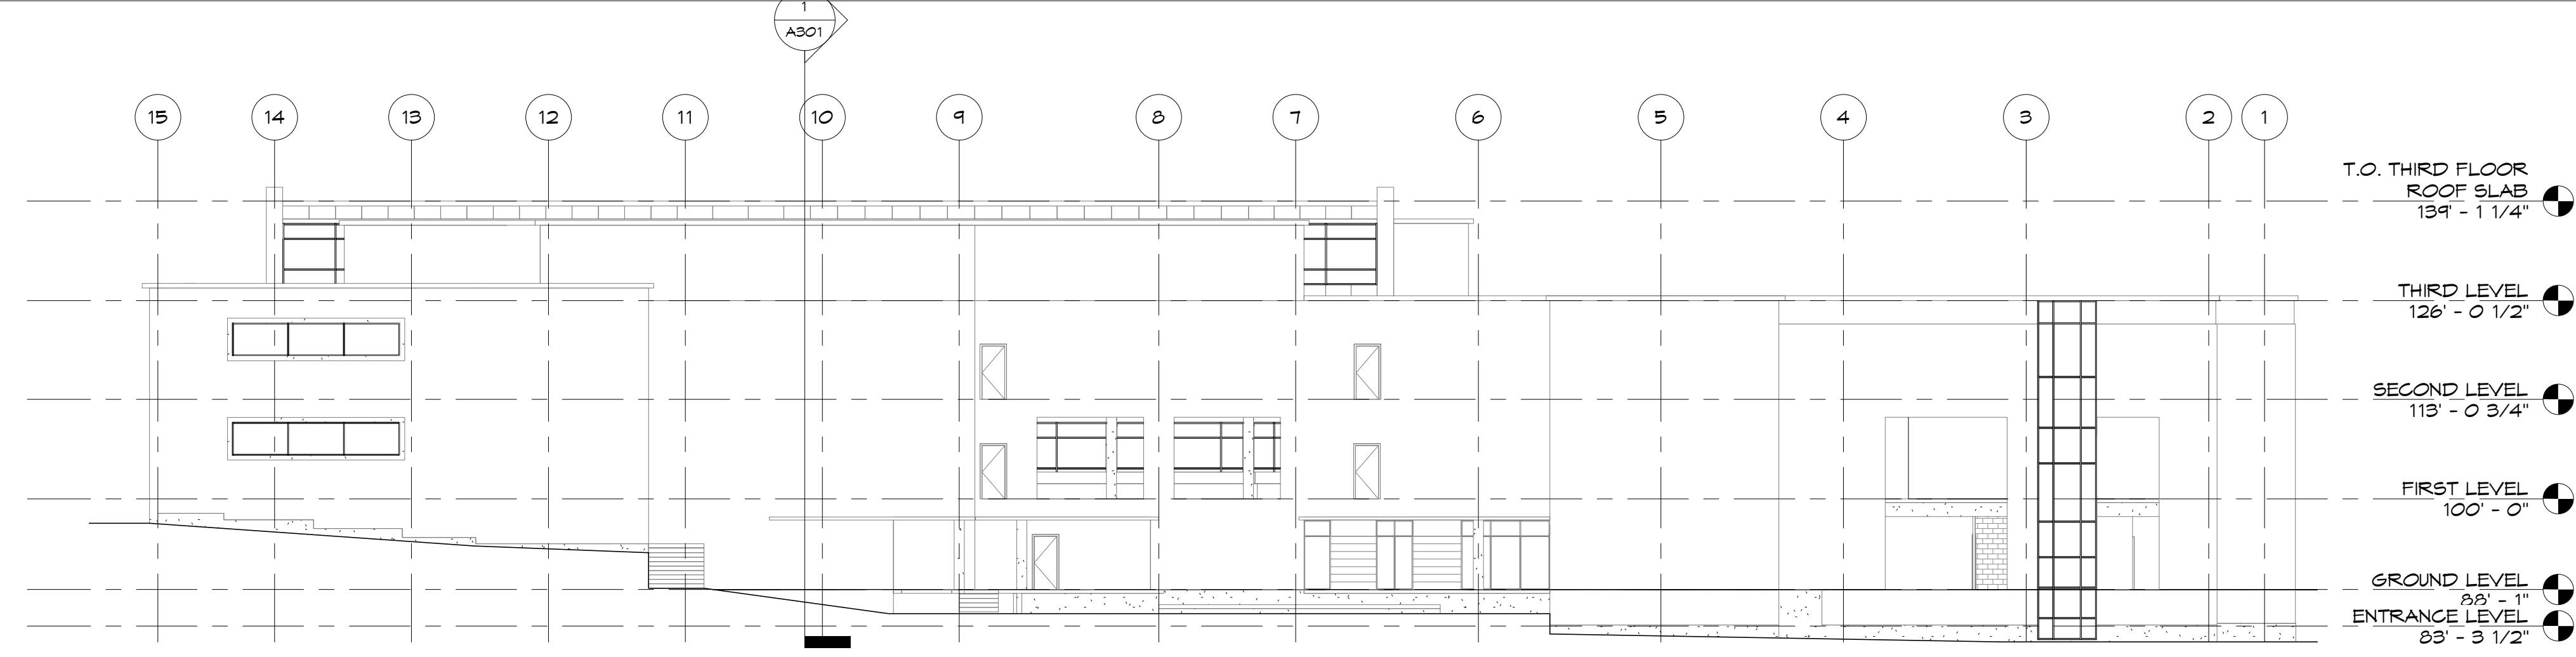


1 WEST ELEVATION
1/16" = 1'-0"

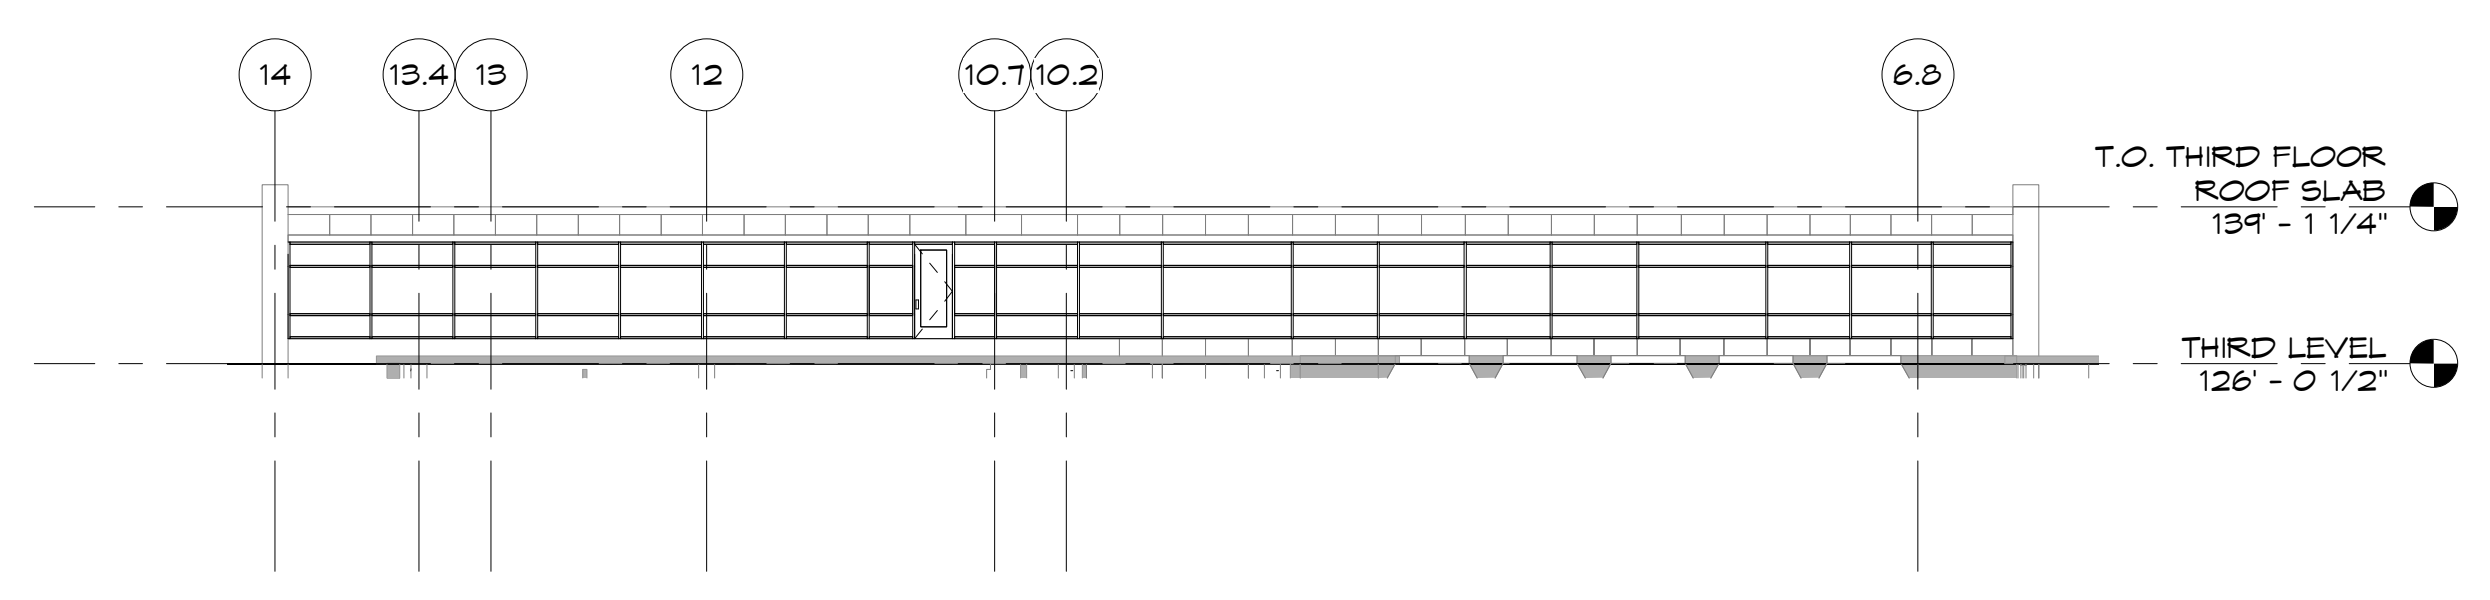


5 THIRD FLOOR WEST WINDOWS
1/16" = 1'-0"

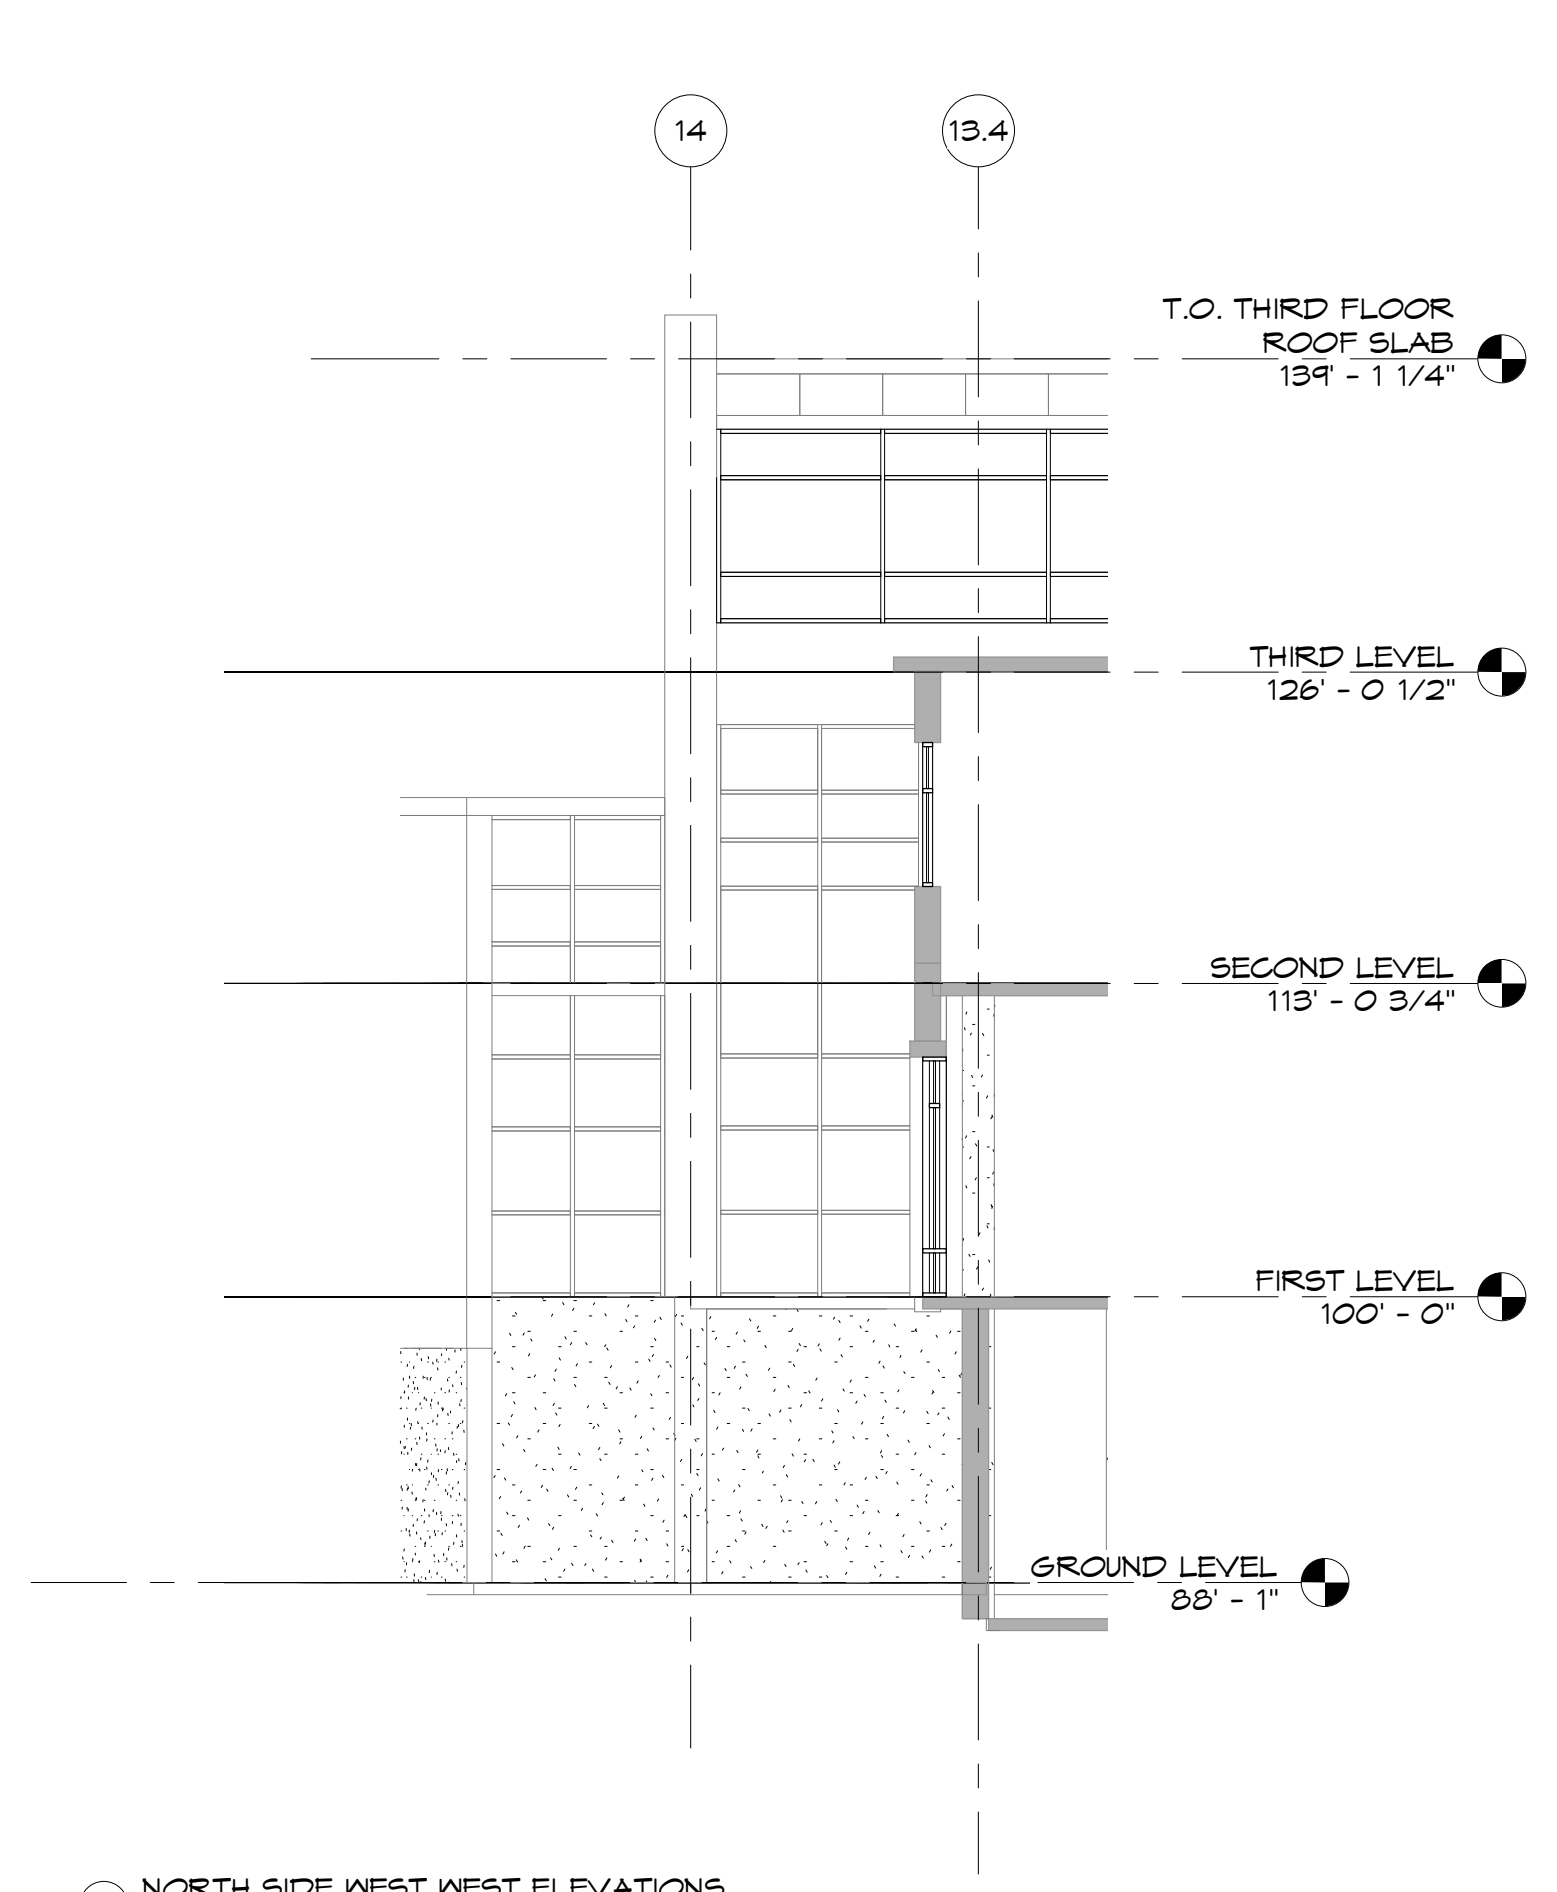


2 NORTH SIDE WEST ELEVATIONS
1/8" = 1'-0"

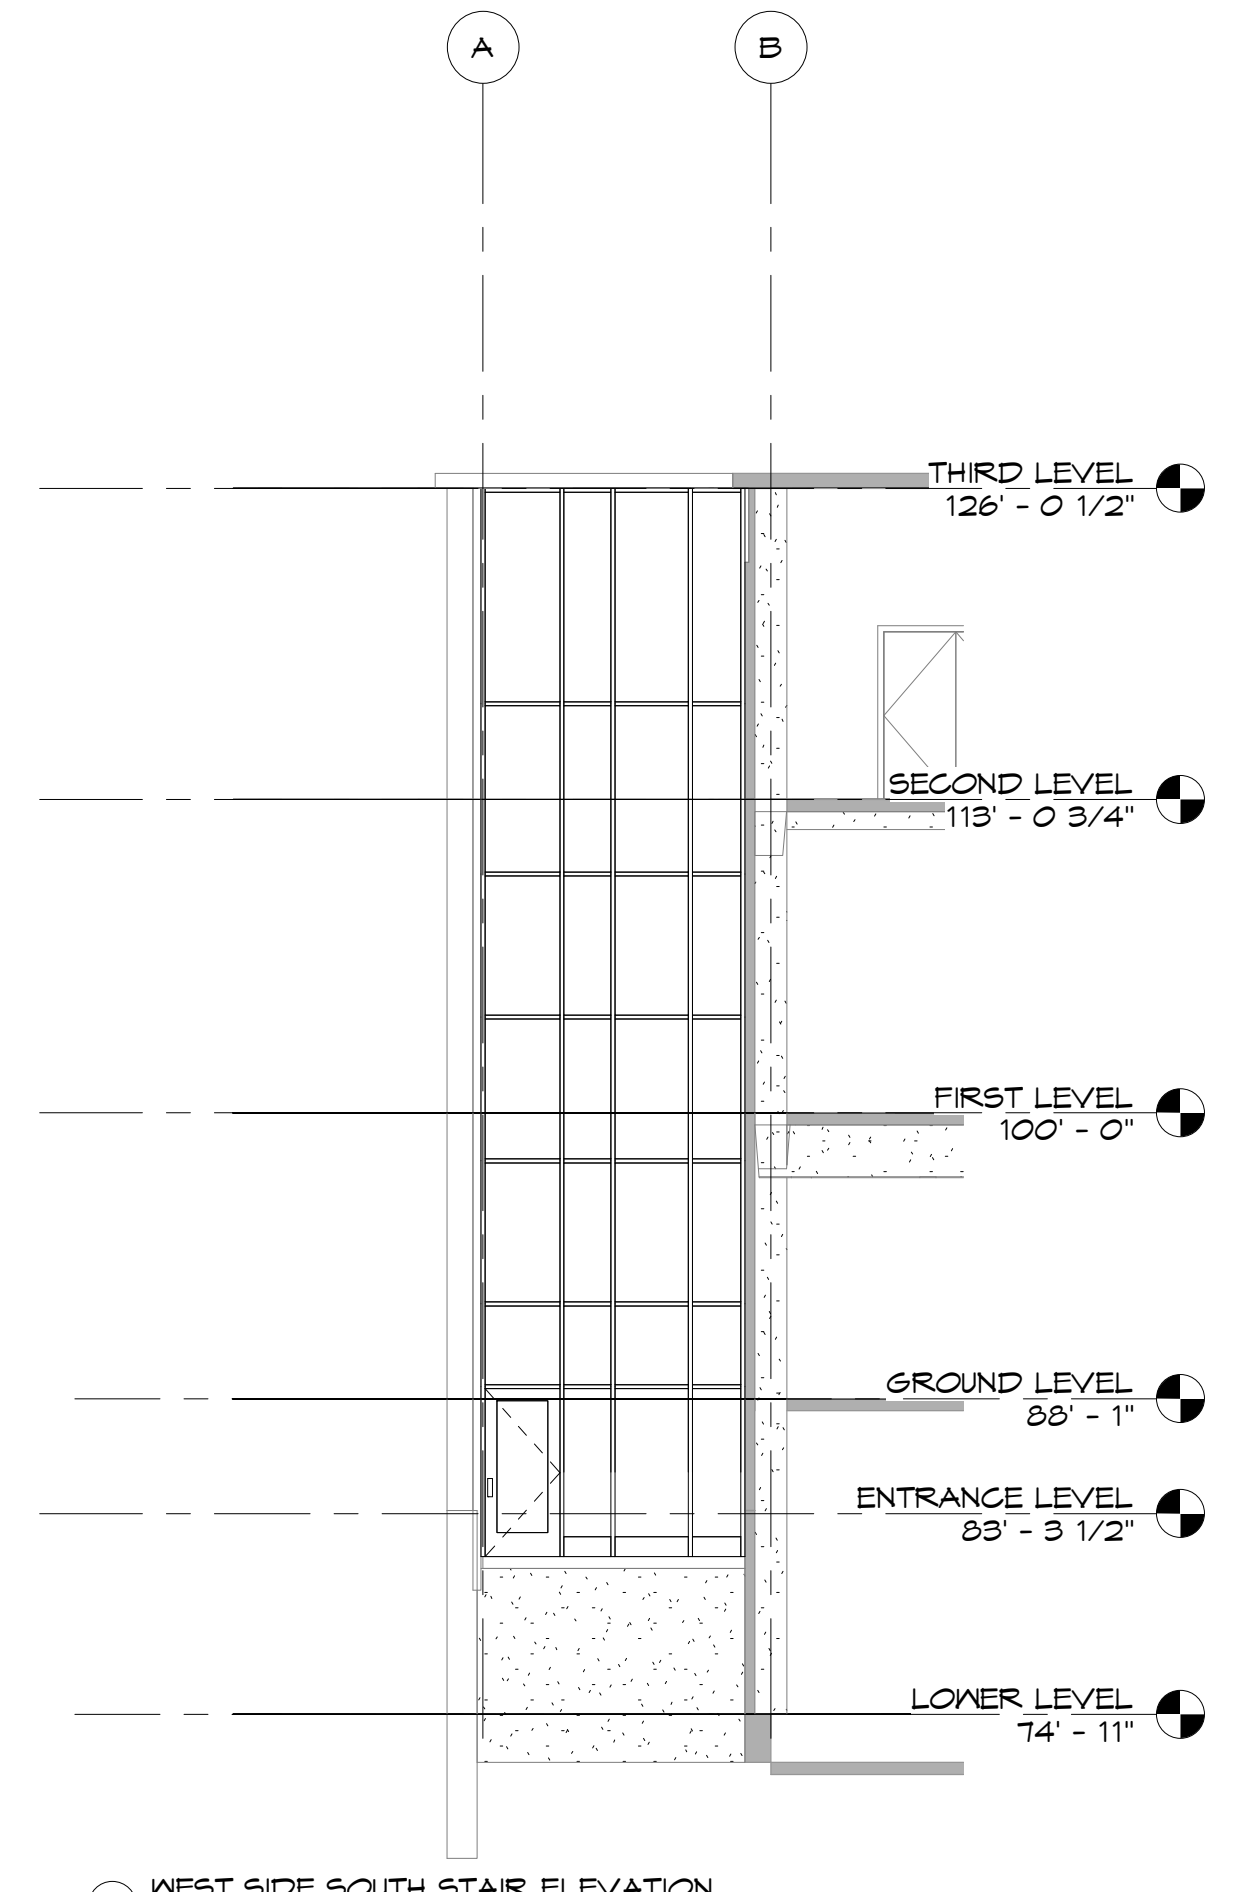

3 WEST SIDE SOUTH STAIR ELEVATION
1/8" = 1'-0"

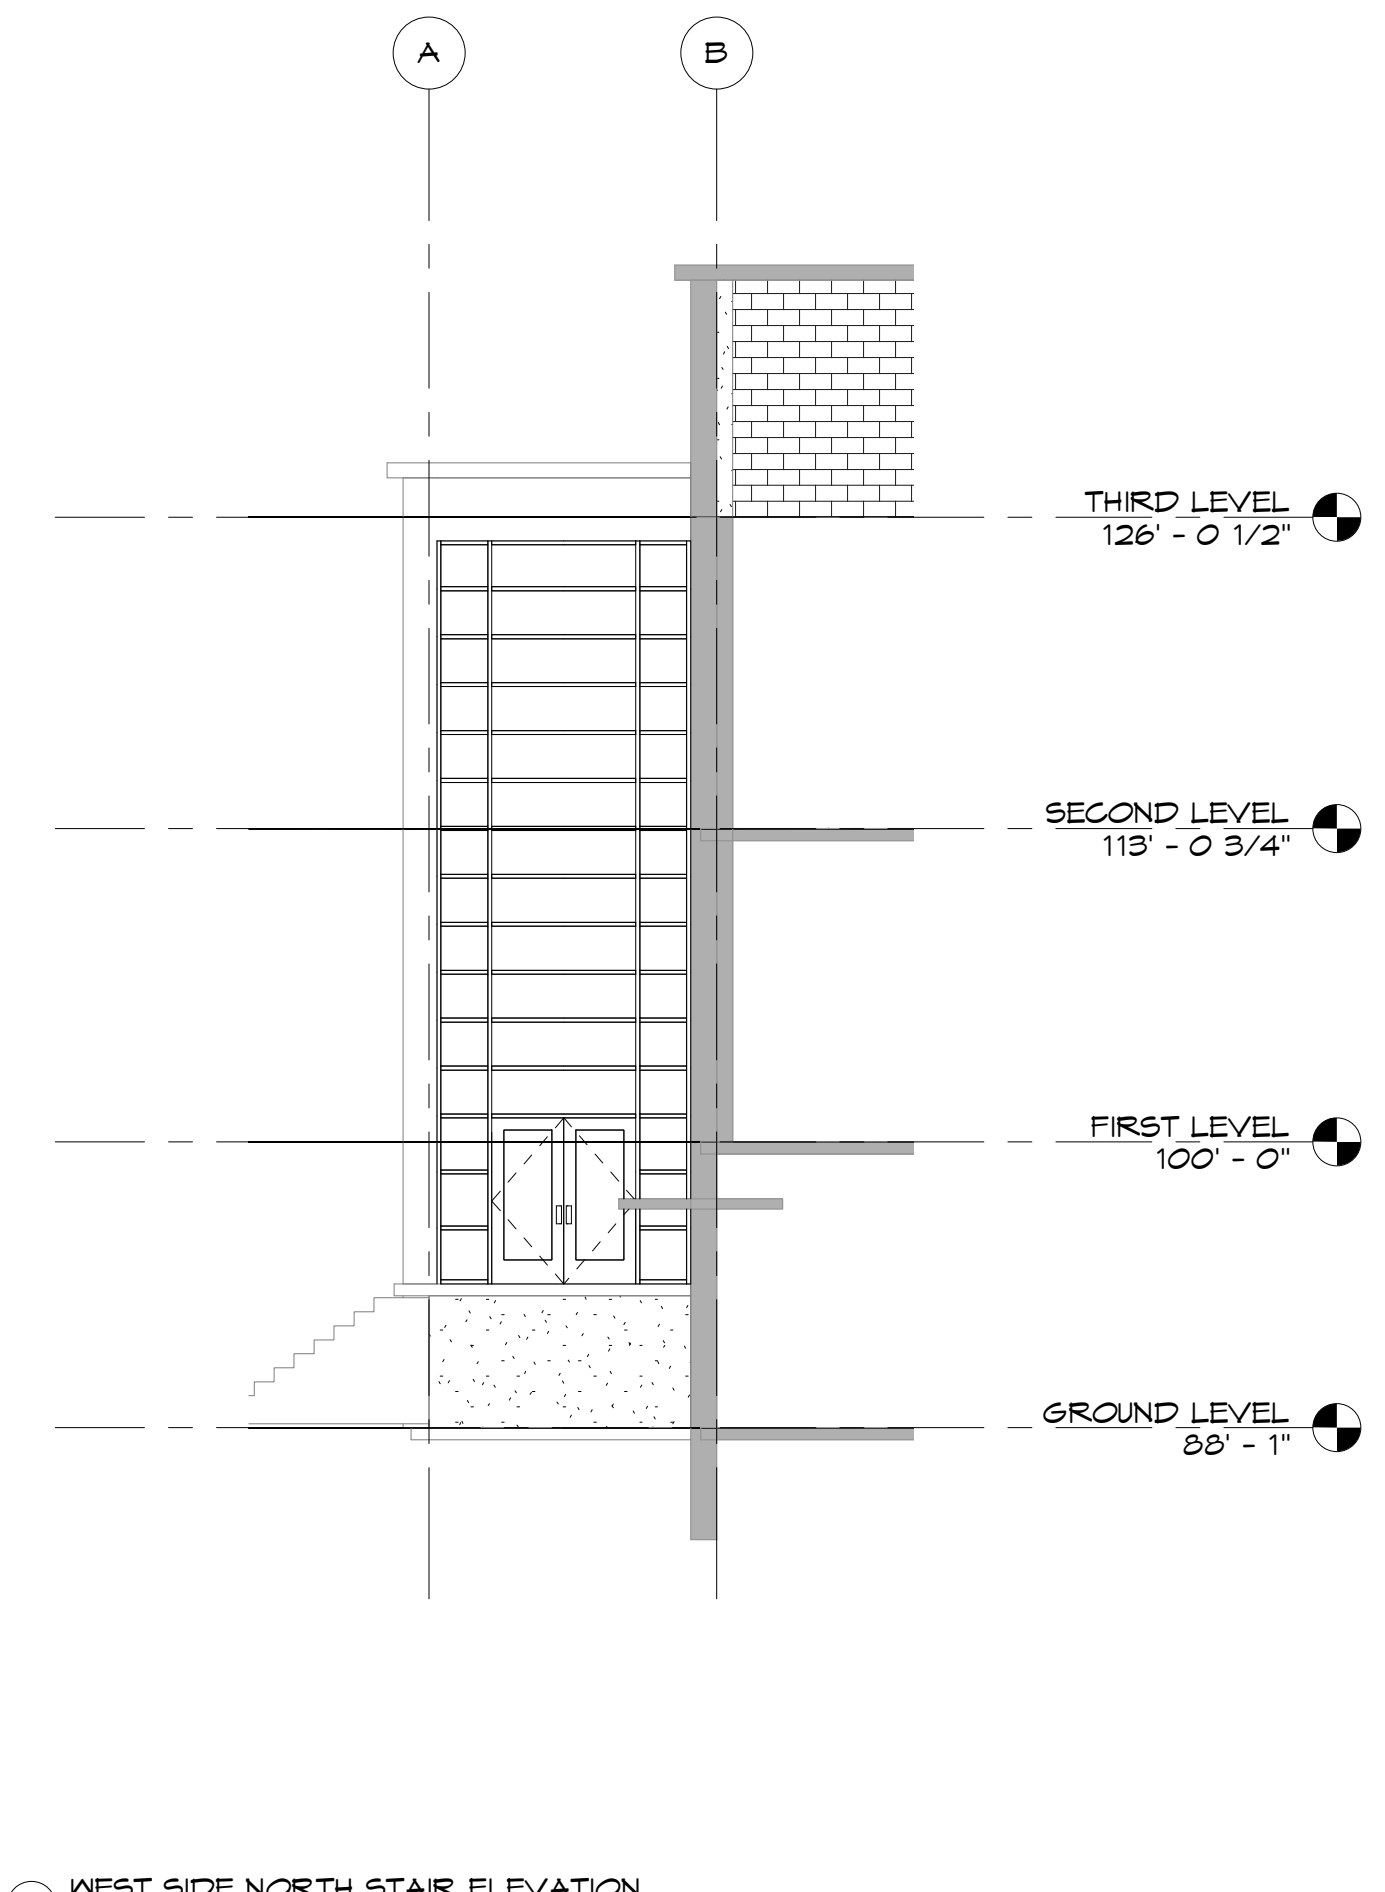

4 WEST SIDE NORTH STAIR ELEVATION
1/8" = 1'-0"

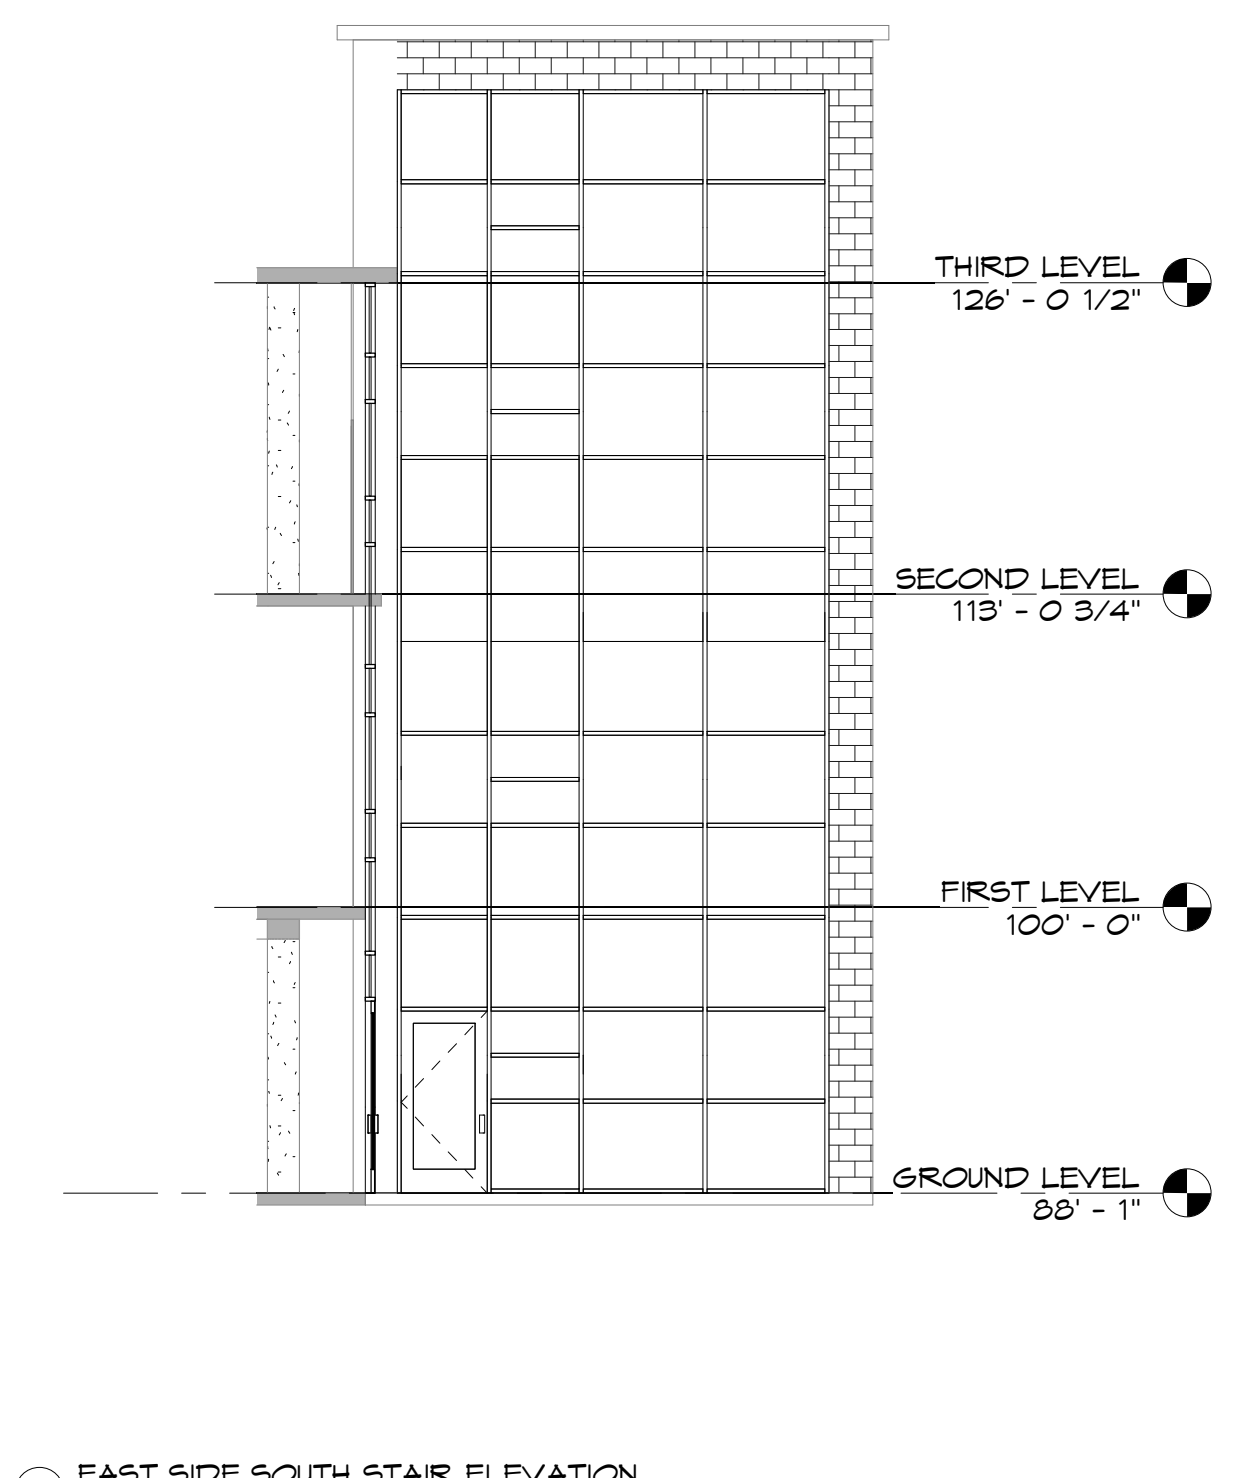

6 EAST SIDE SOUTH STAIR ELEVATION
1/8" = 1'-0"

PROGRESS DOCUMENT
NOT FOR CONSTRUCTION

KSU DWG NO.
DR 2014-XXX

SHEET
OF

TOTAL SHEETS IN SET
XXX

Department of Administration
Office of Construction Management
Landon Street Office Building
800 SW Jackson, Suite 700
Topeka, Kansas 66612-1216
Phone 785-296-8899
Fax 785-296-8898

KANSAS STATE UNIVERSITY
STUDENT UNION RENOVATION
KSU STUDENT UNION - MANHATTAN, KS 66502
BUILDING NUMBER 36700-00101
DATE: Issue
BY: Author
CHECKED BY: Checker
REV: No

EXTERIOR ELEVATIONS

A-012552

A204

SCHEMATIC DESIGN

PROGRESS DOCUMENT
NOT FOR CONSTRUCTION

KSU DWG NO.
DR 2014-XXX

SHEET
OF

TOTAL SHEETS IN SET
XXX

Department of Administration
Office of Construction Management
Landon Street Office Building
800 SW Jackson, Suite 700
Topeka, Kansas 66612-1216
Phone 785-296-8899
Fax 785-296-8898


KANSAS STATE UNIVERSITY
STUDENT UNION RENOVATION
KSU STUDENT UNION - MANHATTAN, KS 66502
BUILDING NUMBER 36700-00101
BY: Author CHECKED BY: Checker REV: No
DATE: Issue Date

SECTIONS


A-012552

A301


SCHEMATIC DESIGN

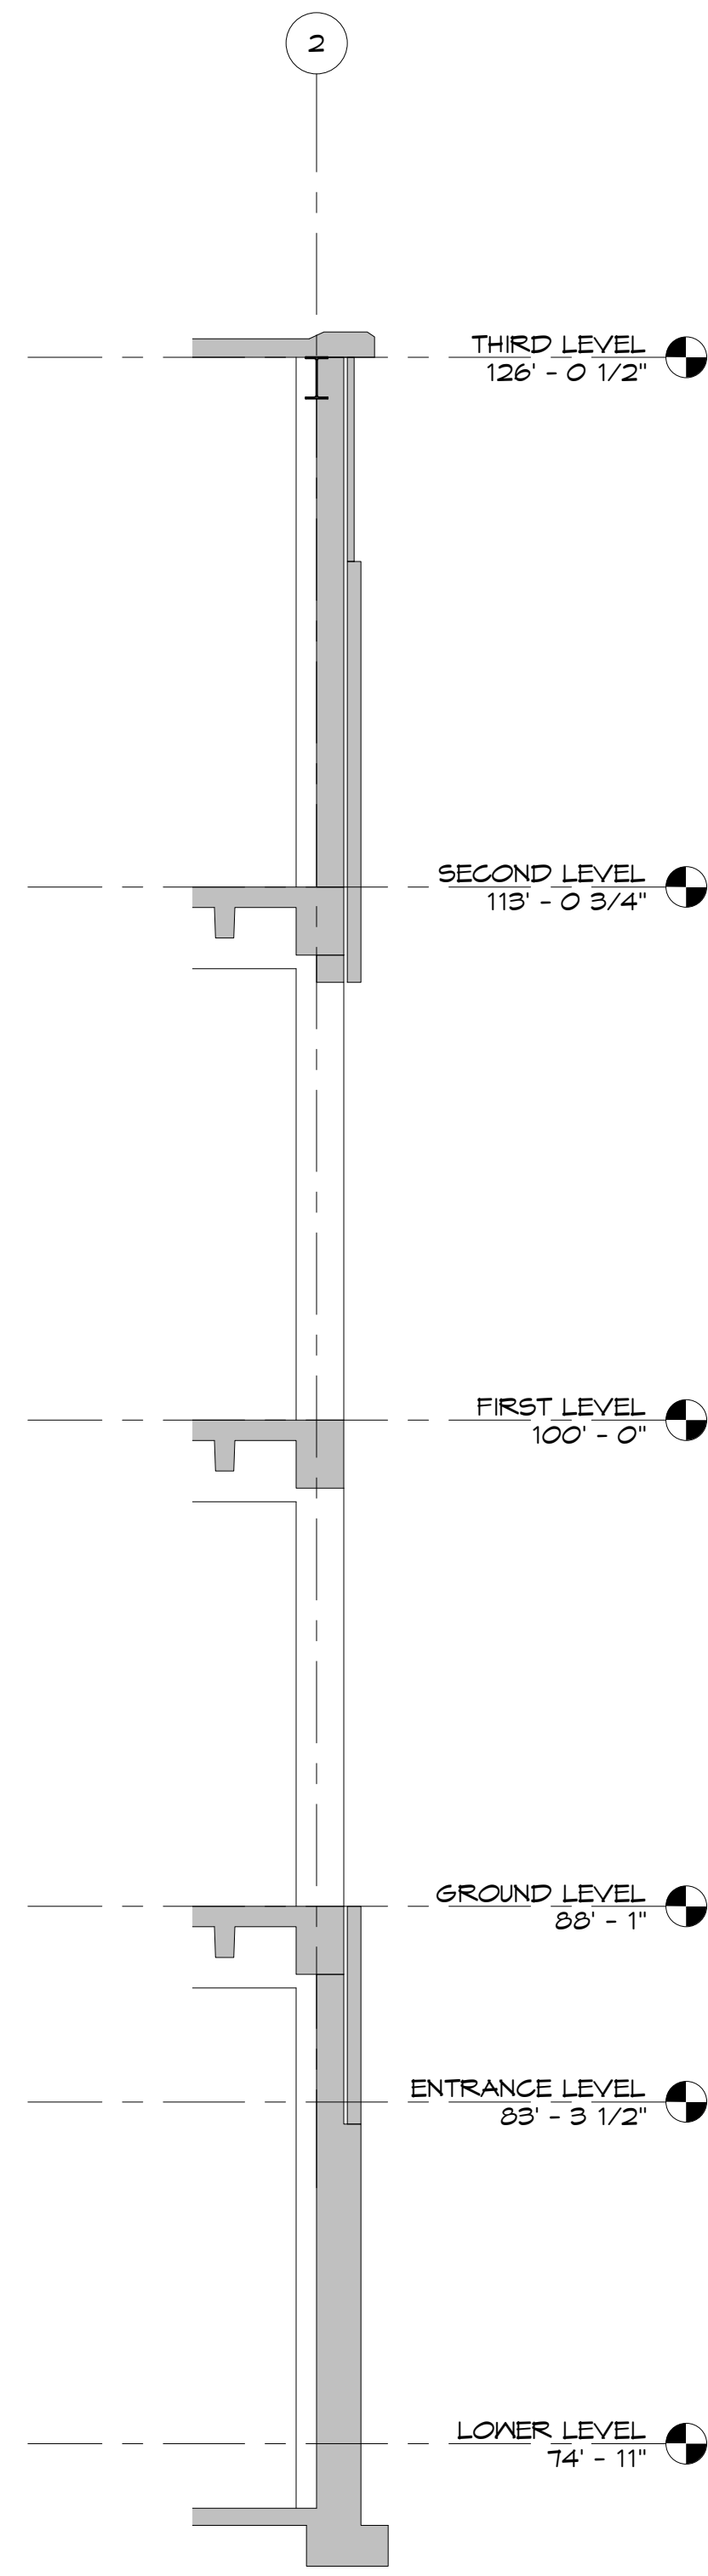


3 South Exterior Wall Openings
1/4" = 1'-0"

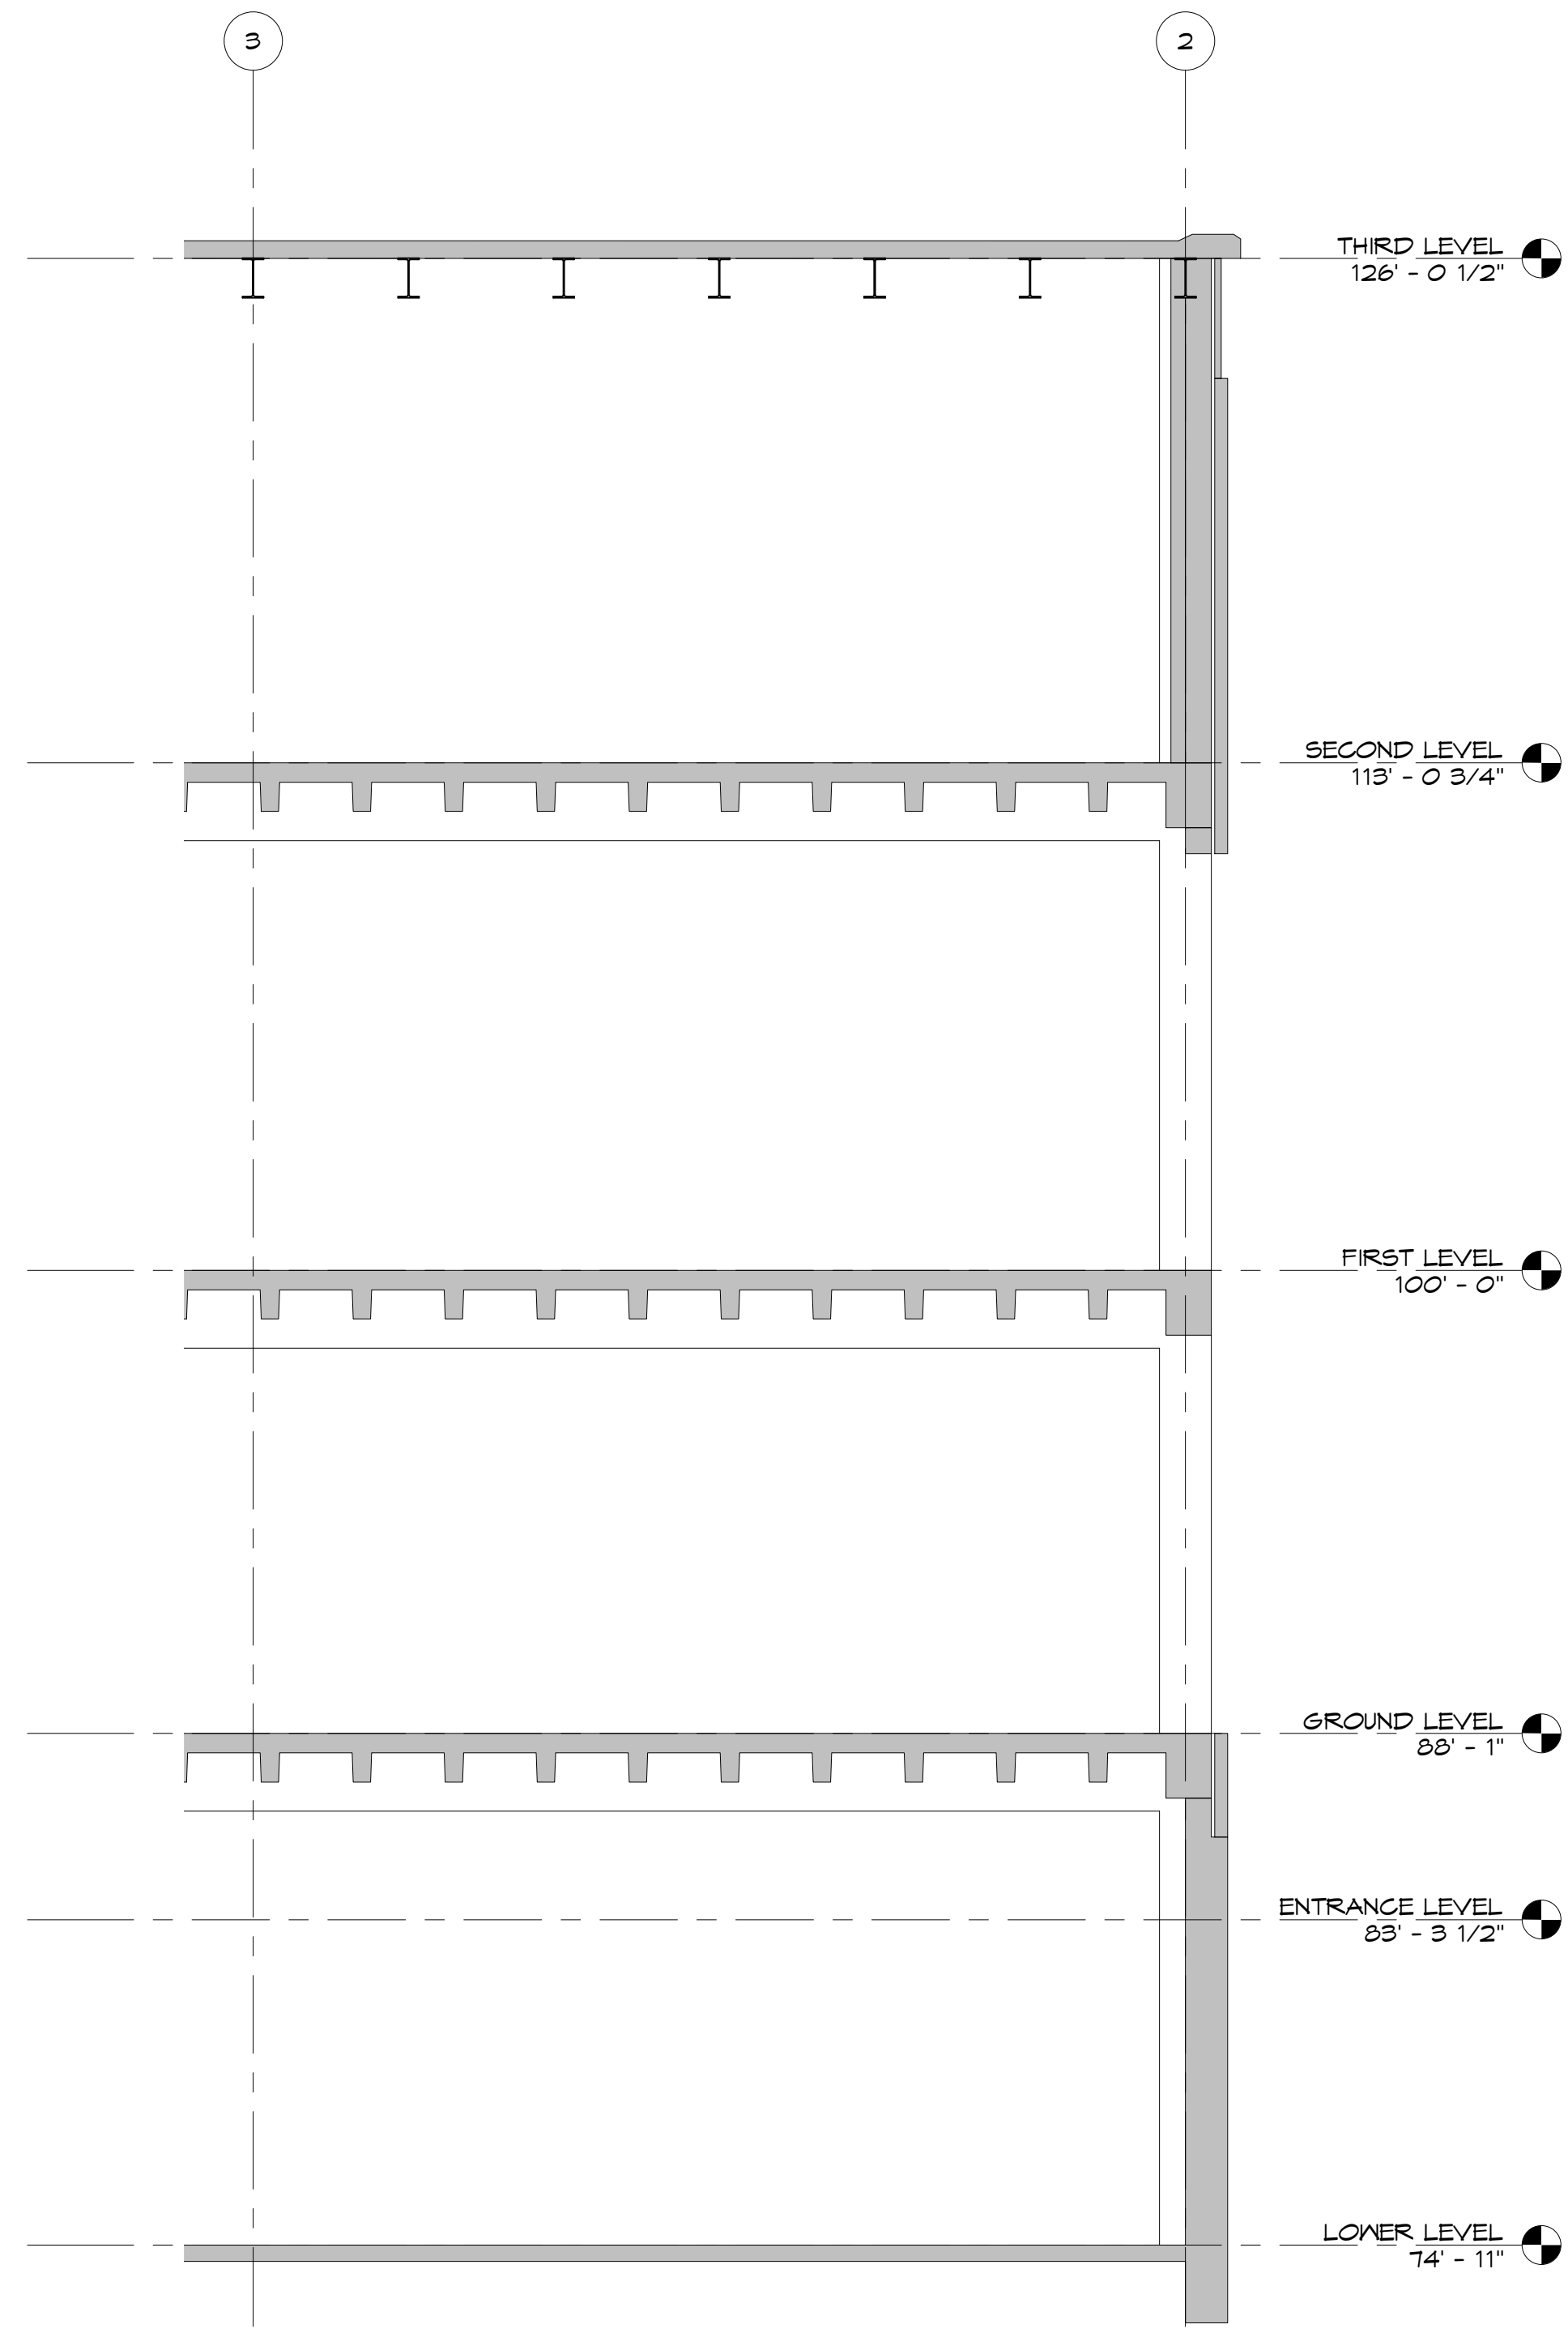

2 South Exterior Wall Opening at Stair
1/4" = 1'-0"

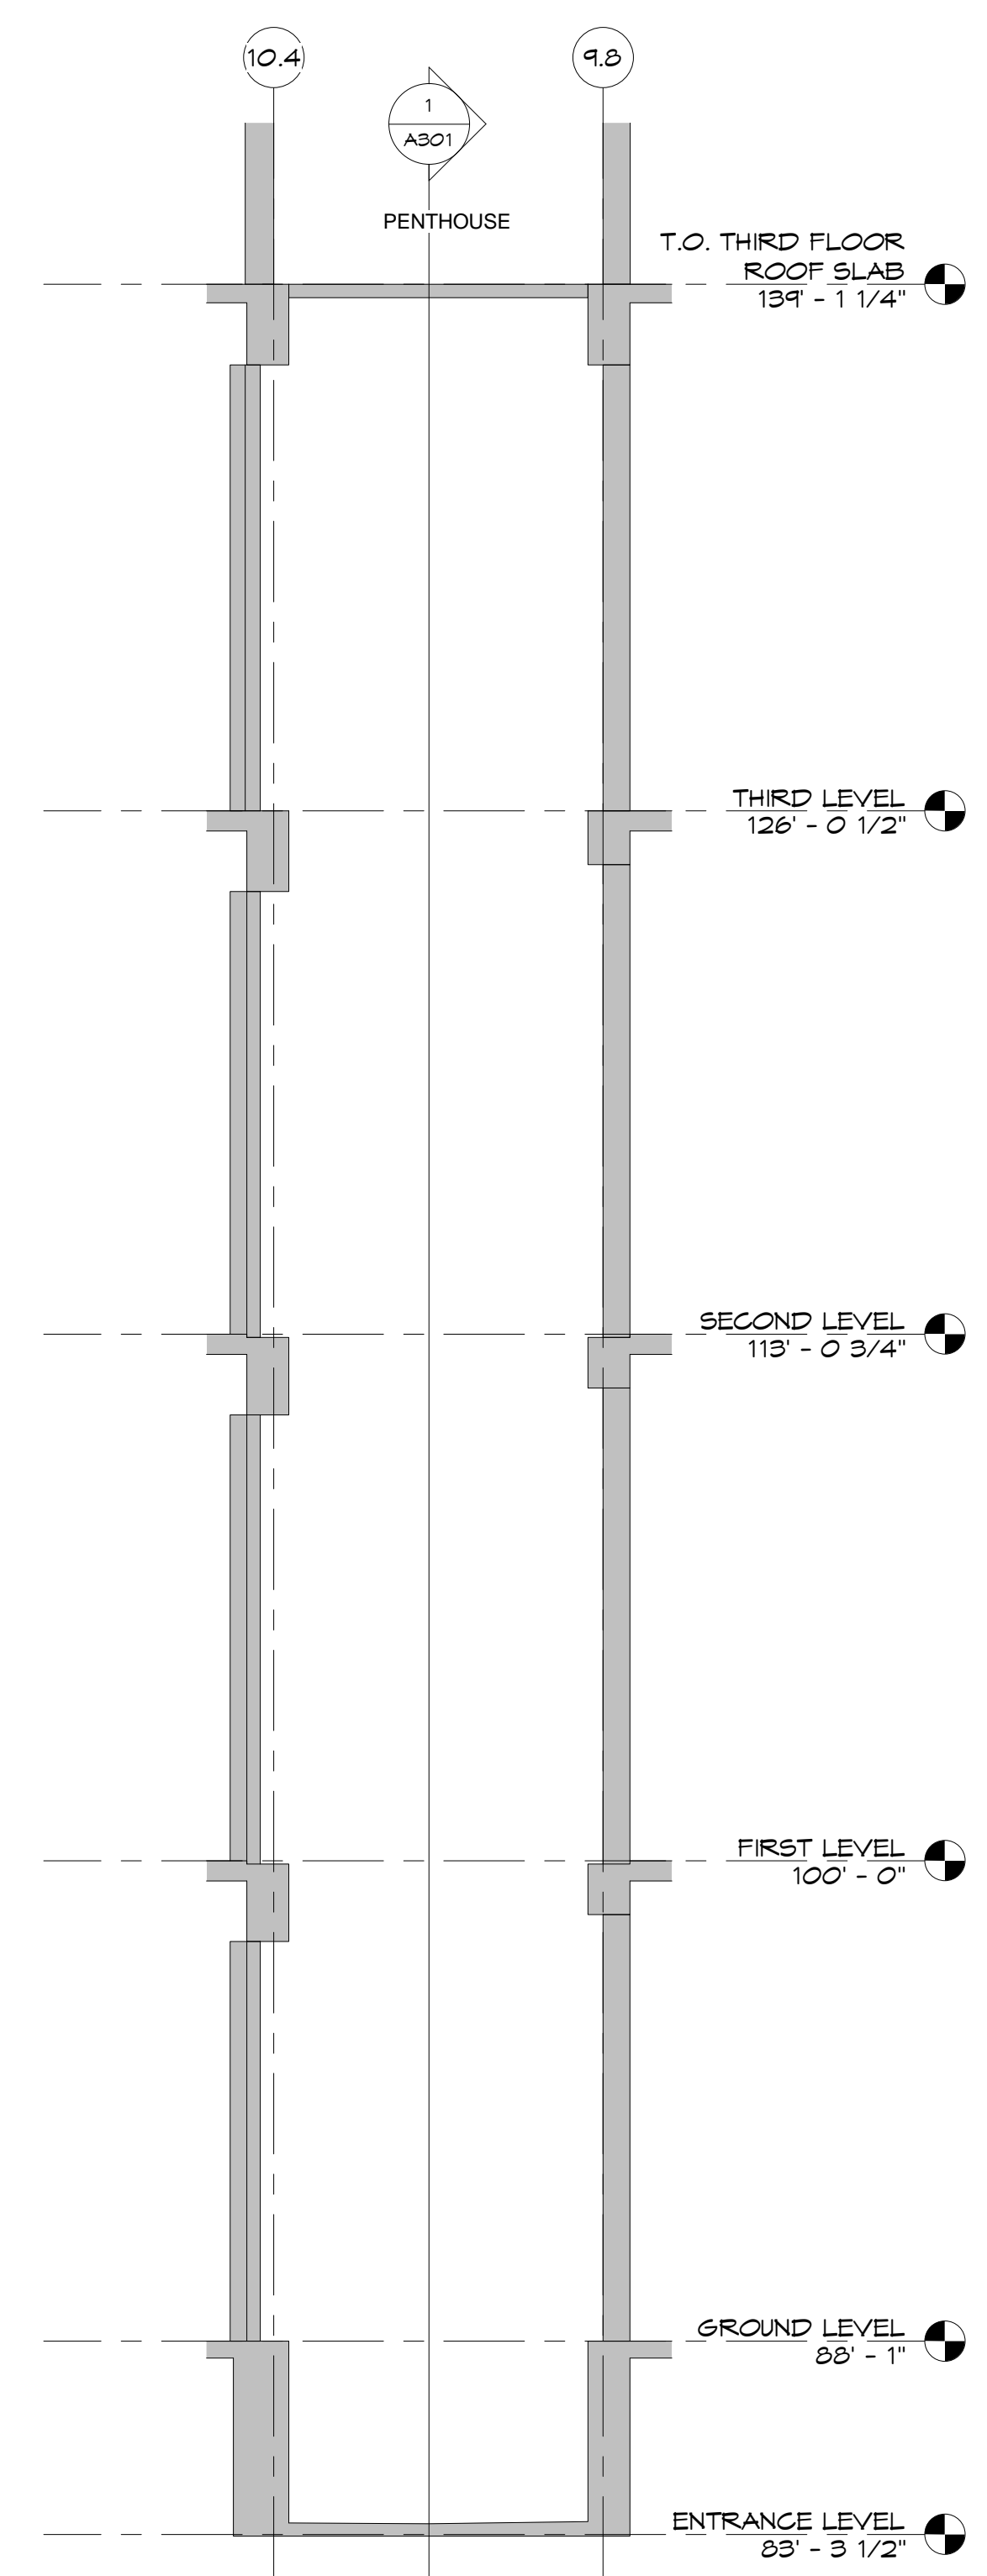

4 Section 4
1/4" = 1'-0"

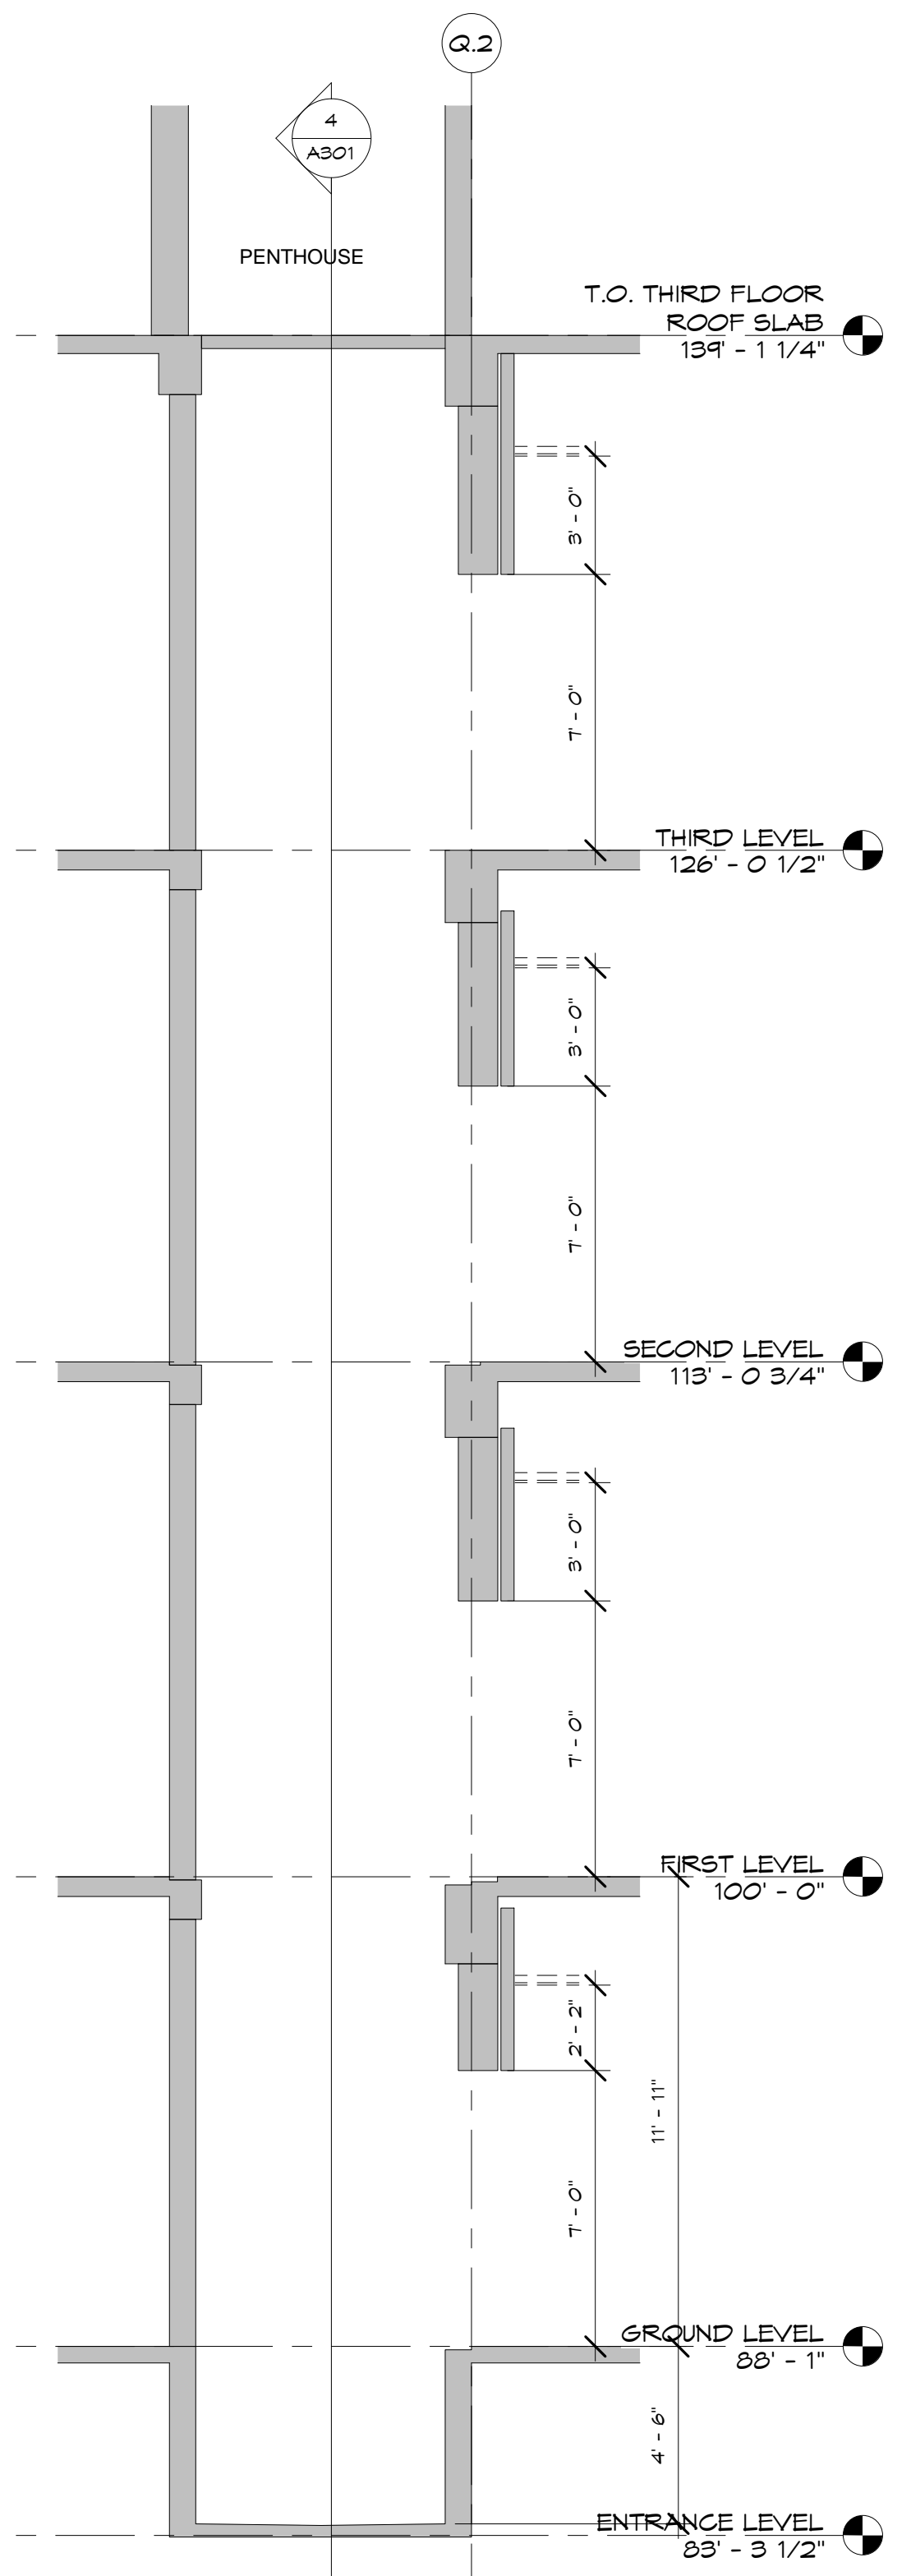

1 ELO03 SECTION
1/4" = 1'-0"